

Procurement & Contracts twubids@twu.edu

ADDENDUM # 1 RFP-731-24-008-JC Bezos Academy Denton

THE PROPOSAL YOU ARE SUBMITTING FOR THE ABOVE RFP NUMBER MUST CONTAIN THE FOLLOWING ADDITION(S).

- 1. Bid Proposal Form referenced throughout document located in the Project Manual by VLK page 27-29. This form must be completed and submitted with proposal.
- 2. Sections 3.5.4 and 3.5.6 in RFP document change to do not apply the building is not attached to another building and there are no occupants.
- 3. Section 3.6.3 building is not occupied does not apply.
- 4. Updated Architect drawings and specs attached herein.

Project No. 23-018.00 March 19, 2024

ADDENDUM NO. 1 TO THE DRAWINGS AND PROJECT MANUAL FOR

TWU - DENTON PRESCHOOL FACILITY TEXAS WOMAN'S UNIVERSITY DENTON, TEXAS



VLK ARCHITECTS, INC.

1320 Hemphill St., Suite 400 Fort Worth, TX 76104 817.633.1600 voice vlkarchitects.com

1.1 GENERAL

- A. This addendum modifies the drawings and project manual, dated February 29, 2024, as noted within and shall become part of the Contract Documents.
- B. Each holder of proposal documents registered with the Owner will receive a copy of the addendum. Each prime proposer is responsible for distribution of information conveyed by this addendum to its sub-proposers and suppliers.

1.2 SECTION 07 72 33 - ROOF HATCHES

A. Delete this section entirely and insert attached revised section.

1.3 REVISED DRAWINGS

A. Sheet Nos. INDEX, C3.00, C4.00, C5.00, C5.01, C7.00, C8.00, C9.00, A1.12, A2.11, A2.31, A2.41, A3.01, A3.12, A3.21, A4.11, A4.31 through A4.35, A5.11, A6.11, A7.11, A9.01 and A9.11, dated March 19, 2024 and attached hereto, are revised drawings and are hereby made a part of this addendum.

1.4 NEW DRAWINGS

A. Sheet No. A7.12, dated March 19, 2024, attached hereto, is a new drawing and is hereby made a part of this addendum.

END OF ADDENDUM NO. 1

SECTION 07 72 33

ROOF HATCHES

PART 1 - GENERAL

1.1 SUMMARY

- A. Section Includes: Roof hatches, including ladder safety post, hatch rail system and safety rail system.
- B. Related Sections:
 - 1. Section 05 50 00 Metal Fabrications; angles miscellaneous metal, and ladder.
 - 2. Section 06 10 00 Rough Carpentry.
 - 3. Section 07 53 00 Single-ply Membrane Roofing.
 - 4. Section 07 62 00 Sheet Metal Flashing and Trim: flashing of the hatch curb.
 - 5. Section 07 72 13 Manufactured Roof Curbs and Portals.
 - 6. Section 07 92 00 Joint Sealants.

1.2 SUBMITTALS

A. Product Data: Submit in accordance with SECTION 01 33 23 - SHOP DRAWINGS, PRODUCT DATA, AND SAMPLES. Include complete manufacturer's catalog cuts and installation requirements for each item specified.

1.3 WARRANTY

- A. Provide manufacturer's standard warranty. Materials shall be free from defects in material and workmanship for a period of:
 - 1. Roof Hatch: Five years.
 - 2. Roof Hatch Rail System: Five years.

PART 2 - PRODUCTS

2.1 ROOF HATCHES

A. Roof Hatches: Provide single leaf roof hatches, 2'-6" x 3'-0", of 14 gage galvanized/galvannealed steel with 22 gage galvanized/galvannealed steel liner. Product/manufacturer; one of the following:

Model No. BRHU; Babcock-Davis Hatchways Inc.

Type S-20; The Bilco Co.

Model No. SAH-CM-12; Bristolite Daylighting Systems

Model No. RB-1; Milcor Limited Partnership

Model No. RHU; Nystrom

B. Construction:

- 1. Hatch shall be factory assembled with heavy pintle hinges, compression spring operators, positive snap latch with turn handles, padlock hasps and neoprene draft seals.
- 2. Curb shall be 12" high with 3½" flanges, fully welded at corners and equipped with integral metal cap flashing.
- 3. Cover shall be insulated with concealed 1" thick fiberglass insulation.
- 4. Curb shall be insulated with 1" thick fiberboard insulation. Fiberglass insulation is not acceptable.
- 5. Cover shall have an automatic hold-open arm with red vinyl grip handle. All hardware shall be cadmium

2.2 LADDER EXTENSION

- A. Basis of Design: Provide ladder extension Model LU-2, "LadderUP" Safety post as manufactured by The Bilco Company.
 - 1. 42" high telescoping extension.
 - 2. Post shall lock automatically when fully extended. Release lever shall disengage the post to allow it to be returned to its lowered position.
 - 3. Adjustable mounting brackets shall fit ladder rung spacing and clamp brackets shall accommodate ladder rungs.
 - 4. Balancing Spring: A stainless steel spring balancing mechanism shall be provided to provide smooth, easy, controlled operation when raising and lower the safety post.

- 5. Hardware: All mounting hardware shall be Type 316 stainless steel.
- 6. Finish: Factory finish of post shall be hot dipped galvanized steel.

2.3 ROOF HATCH RAIL SYSTEM

- A. Basis of Design: Where noted on drawings, provide roof hatch and fall protection rails manufactured by BlueWater Manufacturing - 4064 Peacey Road, Chaska MN 55318 (866).933.2935; www.bluewater-mfg.com email info@bluewater-mfg.com.
 - 1. Roof hatch safety rail kit #500044, Non-penetrating size as required.
 - 2. Provide guardrails complete with front, side, gate, bases, pens, and other parts required for a compete installation.
 - 3. Hatch rail system shall satisfy the requirements of OSHA 29 CFR 1910.29 and shall meet OSHA strength requirements with a factor of safety of two.
 - 4. Self-closing gate.
 - 5. Color: Safety yellow.

2.4 SAFETY GUARD RAILS PLUS BASE KITS

- A. Basis of Design: Where noted on drawings, provide safety guard rails manufactured by BlueWater Manufacturing 4064 Peacey Road, Chaska MN 55318 (866).933.2935; www.bluewater-mfg.com email info@bluewater-mfg.com.
 - 1. Safety Guard Rail #2000 "SR2K", Non-penetrating passive fall system as indicated.
 - 2. Safety rail system shall satisfy the requirements of OSHA 29 CFR 1910.23 and 1926.502.
 - 3. Constructed of 1-5/8" steel tubing powder coated safety yellow.
 - 4. Cast iron bases powder coated safety yellow with EPDM pads to protect the roof membrane.

PART 3 - EXECUTION

3.1 INSPECTION

- A. Verify that ladder safety post or hatch rail system installations will not disrupt other trades.
- B. Verify that the ladder rungs are dry, clean, and free of foreign matter.
- C. Report and correct defects prior to any installation.

3.2 INSTALLATION

- A. Roof Hatch: Install roof hatches in accordance with the manufacturer's recommendations. Securely fasten to the roof deck with bolts or screws.
- B. Roof Hatch Railing System: Hatch rail system shall not penetrate any roofing material.
- C. Installer shall field check conditions and verify the manufacturer's ladder safety post and hatch rail system details for accuracy to fit the application prior to fabrication.
- D. Installer shall comply with the ladder safety post and hatch rail system manufacturer's installation instructions.
- E. The manufacturer shall furnish fasteners necessary for installations.

END OF SECTION

JQ Engineering 100 Glass Street, Suite 201 Dallas, Texas 75201 Main Phone: 214.752.9098

M.E.P. ENGINEER

106 Decker Dr, Suite 200 Irving, Texas 75062 Main Phone: 972.812.1270 www.salasobrien.com


Drawn By Author Quality Control

SHEET TITLE

GENERAL NOTES **ABBREVIATIONS**

TWU - Denton Preschool Facility TEXAS WOMAN'S UNIVERSITY

DENTON, TEXAS

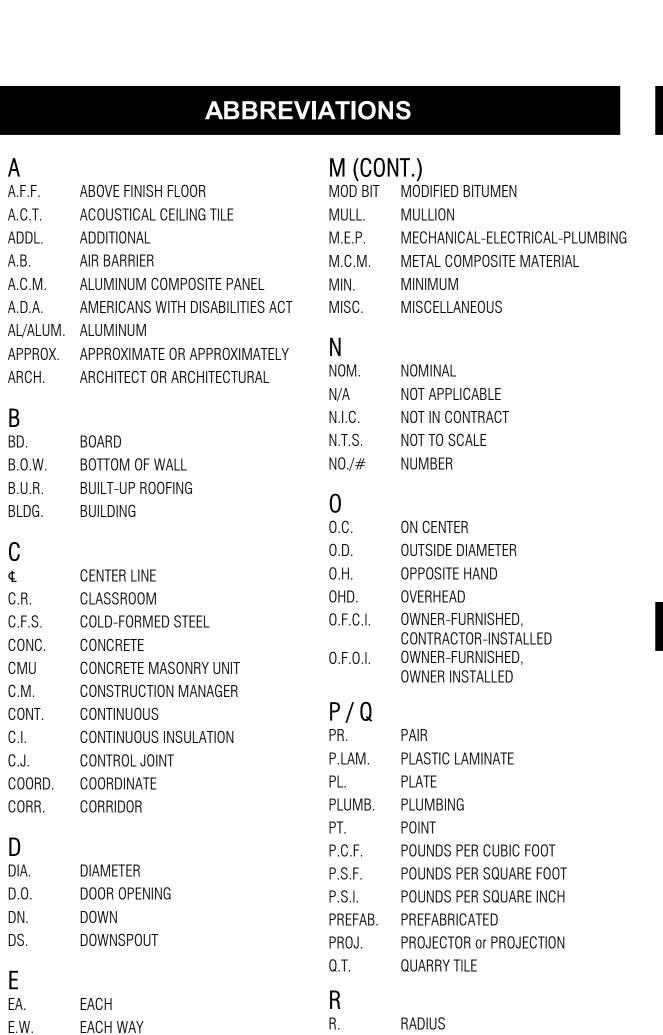

ELECTRICAL

EQUAL

EQUIPMENT

FEET or FOOT

FINISH FLOOR

FLOOR DRAIN

FLUORESCENT

GALVANIZED

HIGH POINT

HOLLOW METAL

HORIZONTAL BLINDS

HOT-DIP GALVANIZED

INTERNATIONAL BUILDING CODE

HORIZONTAL

INSUL. INSULATION

INTERIOR

LAVATORY

L.V.T. LUXURY VINYL TILE

LONG LEG HORIZONTA

MANUFACTURER

MANUFACTURING MARKER BOARD

MECHANICAL

FIRE EXTINGUISHER

FIRE HOSE CABINET

FIRE EXTINGUISHER & CABINET

FLAT-HEAD COUNTERSUNK

GENERAL CONTRACTOR

EXPANSION JOINT

EQUIP.

F.D.

FLUOR.

GALV.

G.O.

GYP

ELECTRIC WATER COOLER

EXTERIOR INSULATION & FINISH SYSTEM R.D.

FIBERGLASS REINFORCED PLASTIC

REINFORCING BAR

REGARDING

REQUIRED

RISER (STAIR)

ROOF DRAIN

SIMILAR

SOLID CORE

SPECIFICATION

SQUARE FOOT

STRUCTURAL

SUSPENDED

TACKBOARD

TACK WALL

TEACHER'S CABINET

TREAD (STAIR) TOP & BOTTOM

TOP OF

TOP OF CURB

TOP OF DECK

TOP OF JOIST

TOP OF STEEL

UNDER COUNTER

VERIFY IN FIELD

V.C.T. VINYL COMPOSITION TILE

W.R.B. WATER-RESISTIVE BARRIER

WORKING POINT

V.W.C VINYL WALL COVERING

W/X/Y/Z

W.C. WATER CLOSET

WIDE

WITHOUT

W.W.F. WELDED WIRE FABRIC

U.L. UNDERWRITERS LABORATORY

UNLESS NOTED OTHERWISE

TOP OF WALL

TYPICAL

TEXAS ACCESSIBILITY STANDARDS

STAINLESS STEEL

SQUARE

ROUGH OPENING

REQD.

R.0.

SPEC.

STRUC.

T.W.

T.O.

T.O.W.

REFRIGERATOR

REFERENCE or REFER TO


REFLECTED CEILING PLAN

REINFORCE or REINFORCING

SOUND ATTENUATION BLANKET

SOUND TRANSMISSION CLASS

S.A.F.B. SOUND ATTENUATION FIRE BLANKET

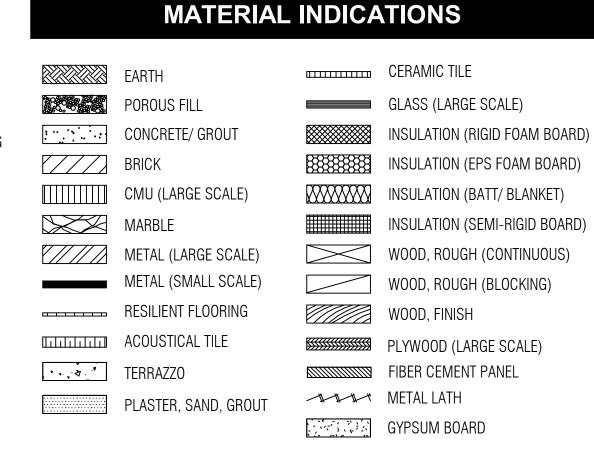

SYMBOLS LEGEND ROOM NAME & NUMBER LOUVER KEYED NOTE NORTH ARROW GLAZED OPENING SYSTEM HOLLOW METAL-FRAMED HORIZONTAL BLINDS GLAZED OPENING SYSTEM INTERIOR ELEVATION **BUILDING ASSEMBLY TYPE** SECTION DETAIL ACCESS CONTROL DATUM ELEVATION

- Notify the Architect of conflicts or variations prior to commencement of construction. joints in masonry veneer, CMU, gypsum board, plaster and stucco to the Architect for review and
- construction, and the resulting interpretations implemented in accordance with the Contract

PROJECT INFORMATION

PROJECT IDENTIFICATION PROJECT NAME: TEXAS WOMAN'S UNIVERSITY - DENTON PRESCHOOL FACILITY OWNER: TEXAS WOMAN'S UNIVERSITY PROJECT NUMBER: 23-018.00 PROJECT LOCATION: 1820 FRAME ST. DENTON TX, 76209

APPROXIMATE BUILDING AREAS

TDLR PROJECT NUMBER: TO BE DETERMINED

TOTAL BLDG AREA.: 10,931 S.F. LEGAL DESCRIPTION: LOT X BLOCK X


BUILDING CONSTRUCTION INFORMATION TYPE OF CONSTRUCTION (TABLE 601 - IBC):

FIRE PROTECTION SYSTEM:


AUTOMATIC SPRINKLER **THROUGHOUT**

- 1. Refer to the CODE-series sheets tor Code Information, Design Criteria and Fire Protection
- Verify and document existing dimensions and conditions at the site before beginning construction. Based on the applicable design criteria, submit Shop Drawings of the proposed pattern of control
- approval prior to construction. 4. In case of discrepancies in or between the Contract Documents, the greater quantity or better quality shall be bid. Clarifications regarding the discrepancies shall be requested from the Architect prior to

SITE LOCATION MAP

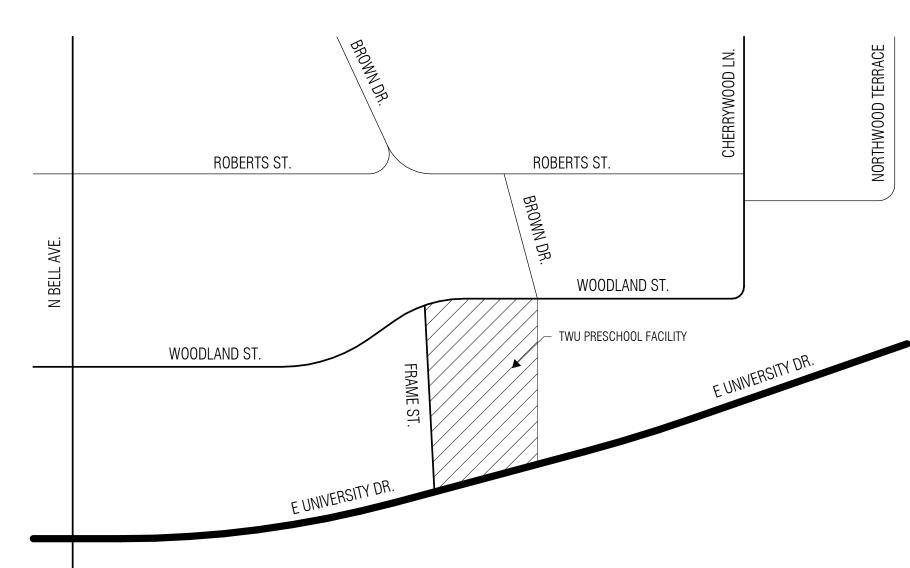

GENERAL NOTES ARCHITECTURAL

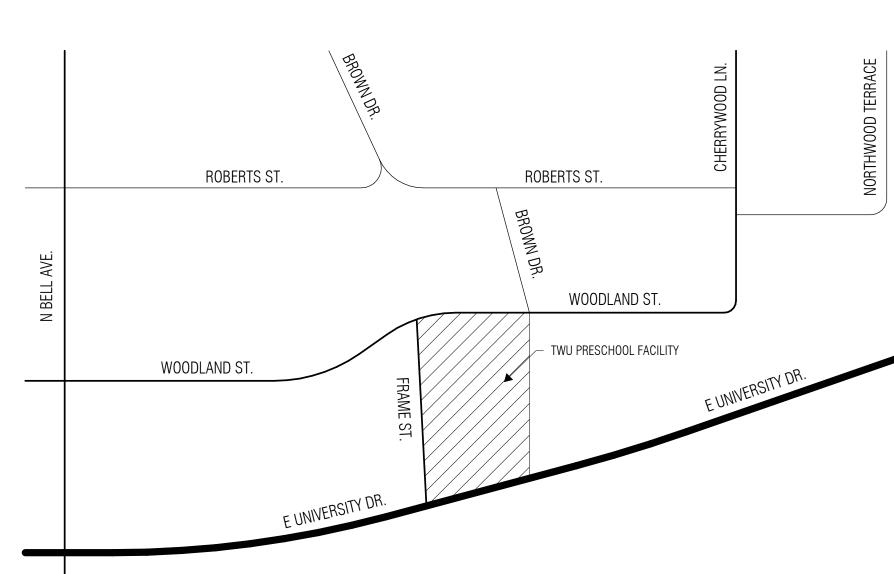

ARCHITECT

VLK Architects, Inc. 1320 Hemphill Street, Suite 400 Fort Worth, Texas 76104 Main Phone: 817.633.1600

www.vlkarchitects.com

JQ Engineering

100 Glass Street, Suite 201

www.jqeng.com LANDSCAPE / IRRIGATION

951 W. Pipeline Rd. Suite 410 Hurst, Texas 76053

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STRUCTURAL NOTES

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TYPICAL WOOD DETAILS

TYPICAL WOOD DETAILS

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MECHANICAL - SCHEDULES

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PLUMBING - FLOOR & ATTIC PLAN

PLUMBING - ENLARGED PLANS

PLUMBING SITE PLAN

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PLUMBING - DETAILS

PLUMBING - RISERS

PLUMBING - RISERS

PLUMBING - SCHEDULES

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TECHNOLOGY DETAILS

TECHNOLOGY DETAILS

TECHNOLOGY DETAILS

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ELECTRICAL

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WALL SECTIONS

WALL SECTIONS

PARTITION TYPES & DETAILS

C10.05 CIVIL DETAILS

C10.06 CIVIL DETAILS

L1.00

L2.00

EXISTING CONDITIONS (1 OF 2)

EXISTING CONDITIONS (2 OF 2)

STRUCTURAL ENGINEER

www.jqeng.com

Salas O'Brien

CONSTRUCTION MANAGER

ISSUED: FEB 29, 2024

REVISIONS Revision Date 03-19-2024 1 Addendum 01

Director Approver Designer Designer

Proj. Arch. Checker PROJECT NO.

23-018.00

INDEX TO DRAWINGS

SHEET NO.



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100% Construction



Revision Date Revision No. 3/19/2024 ADDENDUM #1

Drawn By: K.Q. Director

Quality Control Designer Proj. Arch.

23-018.00

SITE & PAVING PLAN



C3.00

PROPOSED SIGN ----- ADA ACCESSIBLE PATH

EXISTING OVERHEAD ELECTRIC LINE EXISTING COMMUNICATION LINE

GRAPHIC SCALE

(IN FEET)

1 inch = 20 ft.

PROPOSED CONCRETE SIDEWALK
SEE DETAIL 04/C10.02

5" STANDARD DUTY CONCRETE SEE DETAIL 03/C10.01

7" DUMPSTER AREA CONCRETE SEE DETAIL 03/C10.01

FIRE LANE — 6" MEDIUM DUTY SEE DETAIL 03/C10.01

RESTORED ASPHALT PAVEMENT SEE GEOTECH REPORT.

PLANTING AREA **SEE LANDSCAPE PLANS.**

PROPOSED EXTENDED SLAB
SEE STRUCTURAL PLANS.

PROPOSED BUILDING

PROPOSED CURB (6" HIGH)

6" MEDIUM DUTY CONCRETE SEE DETAIL 03/C10.01

Legend

---- BUILDING OVERHANG/COVERED PORCH

Notes


- 1. NO CONSTRUCTION SHALL COMMENCE WITHIN THE CITY OF DENTON RIGHT OF WAY UNTIL ALL NECESSARY PERMITS HAVE BEEN OBTAINED.
- 2. SEE STRUCTURAL PLANS FOR FULL EXTENT OF SLAB.
- 3. SIDEWALK SHOWN AROUND BUILDING TO BEGIN AT EDGE OF EXTENDED SLAB NOT AT EDGE OF BUILDING. 4. SEE MEP PLANS FOR EXACT LOCATION AND DESIGN OF A/C CONDENSER UNITS.
- 5. SEE LANDSCAPE PLANS FOR DETAILED DESIGN OF PLAYGROUND AREA.
- 6. SEE CIVIL DETAILS FOR REFERENCED ITEMS ON SITE

Documents



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100% Construction Documents

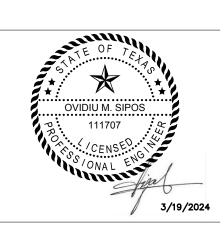

ADDENDUM #1

Drawn By: K.Q. Director

Designer Quality Control Proj. Arch.


23-018.00

FIRE PROTECTION PLAN

C4.00

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JQ INFRASTRUCTURE, LLC 100 GLASS STREET, SUITE 201 972.392.7340 DALLAS, TEXAS 75207 TBPE FIRM 7986

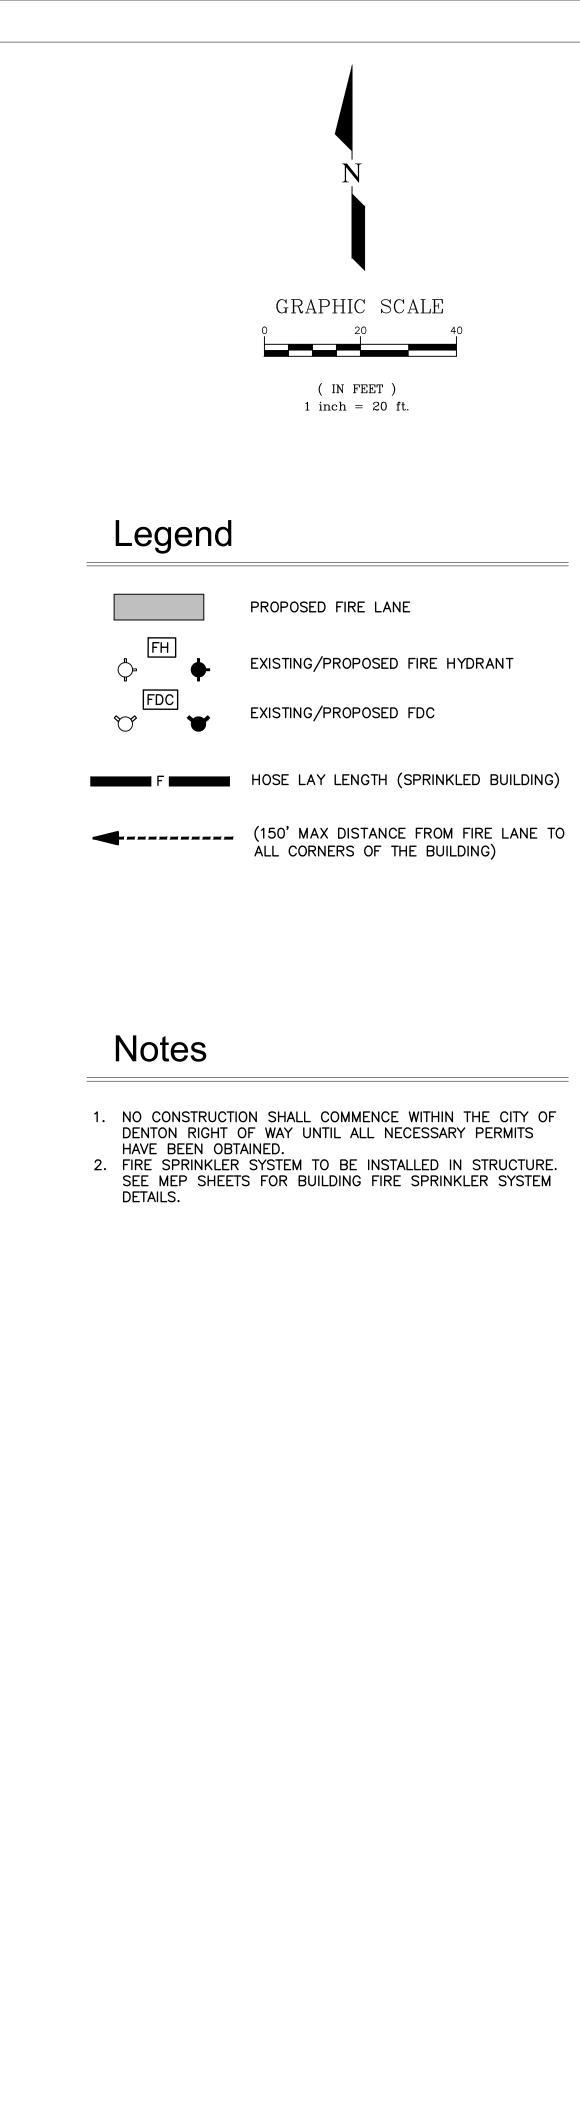


Revision Date

Director Drawn By: K.Q.

GRADING PLAN

JQ INFRASTRUCTURE, LLC 100 GLASS STREET, SUITE 201 972.392.7340 DALLAS, TEXAS 75207 TBPE FIRM 7986

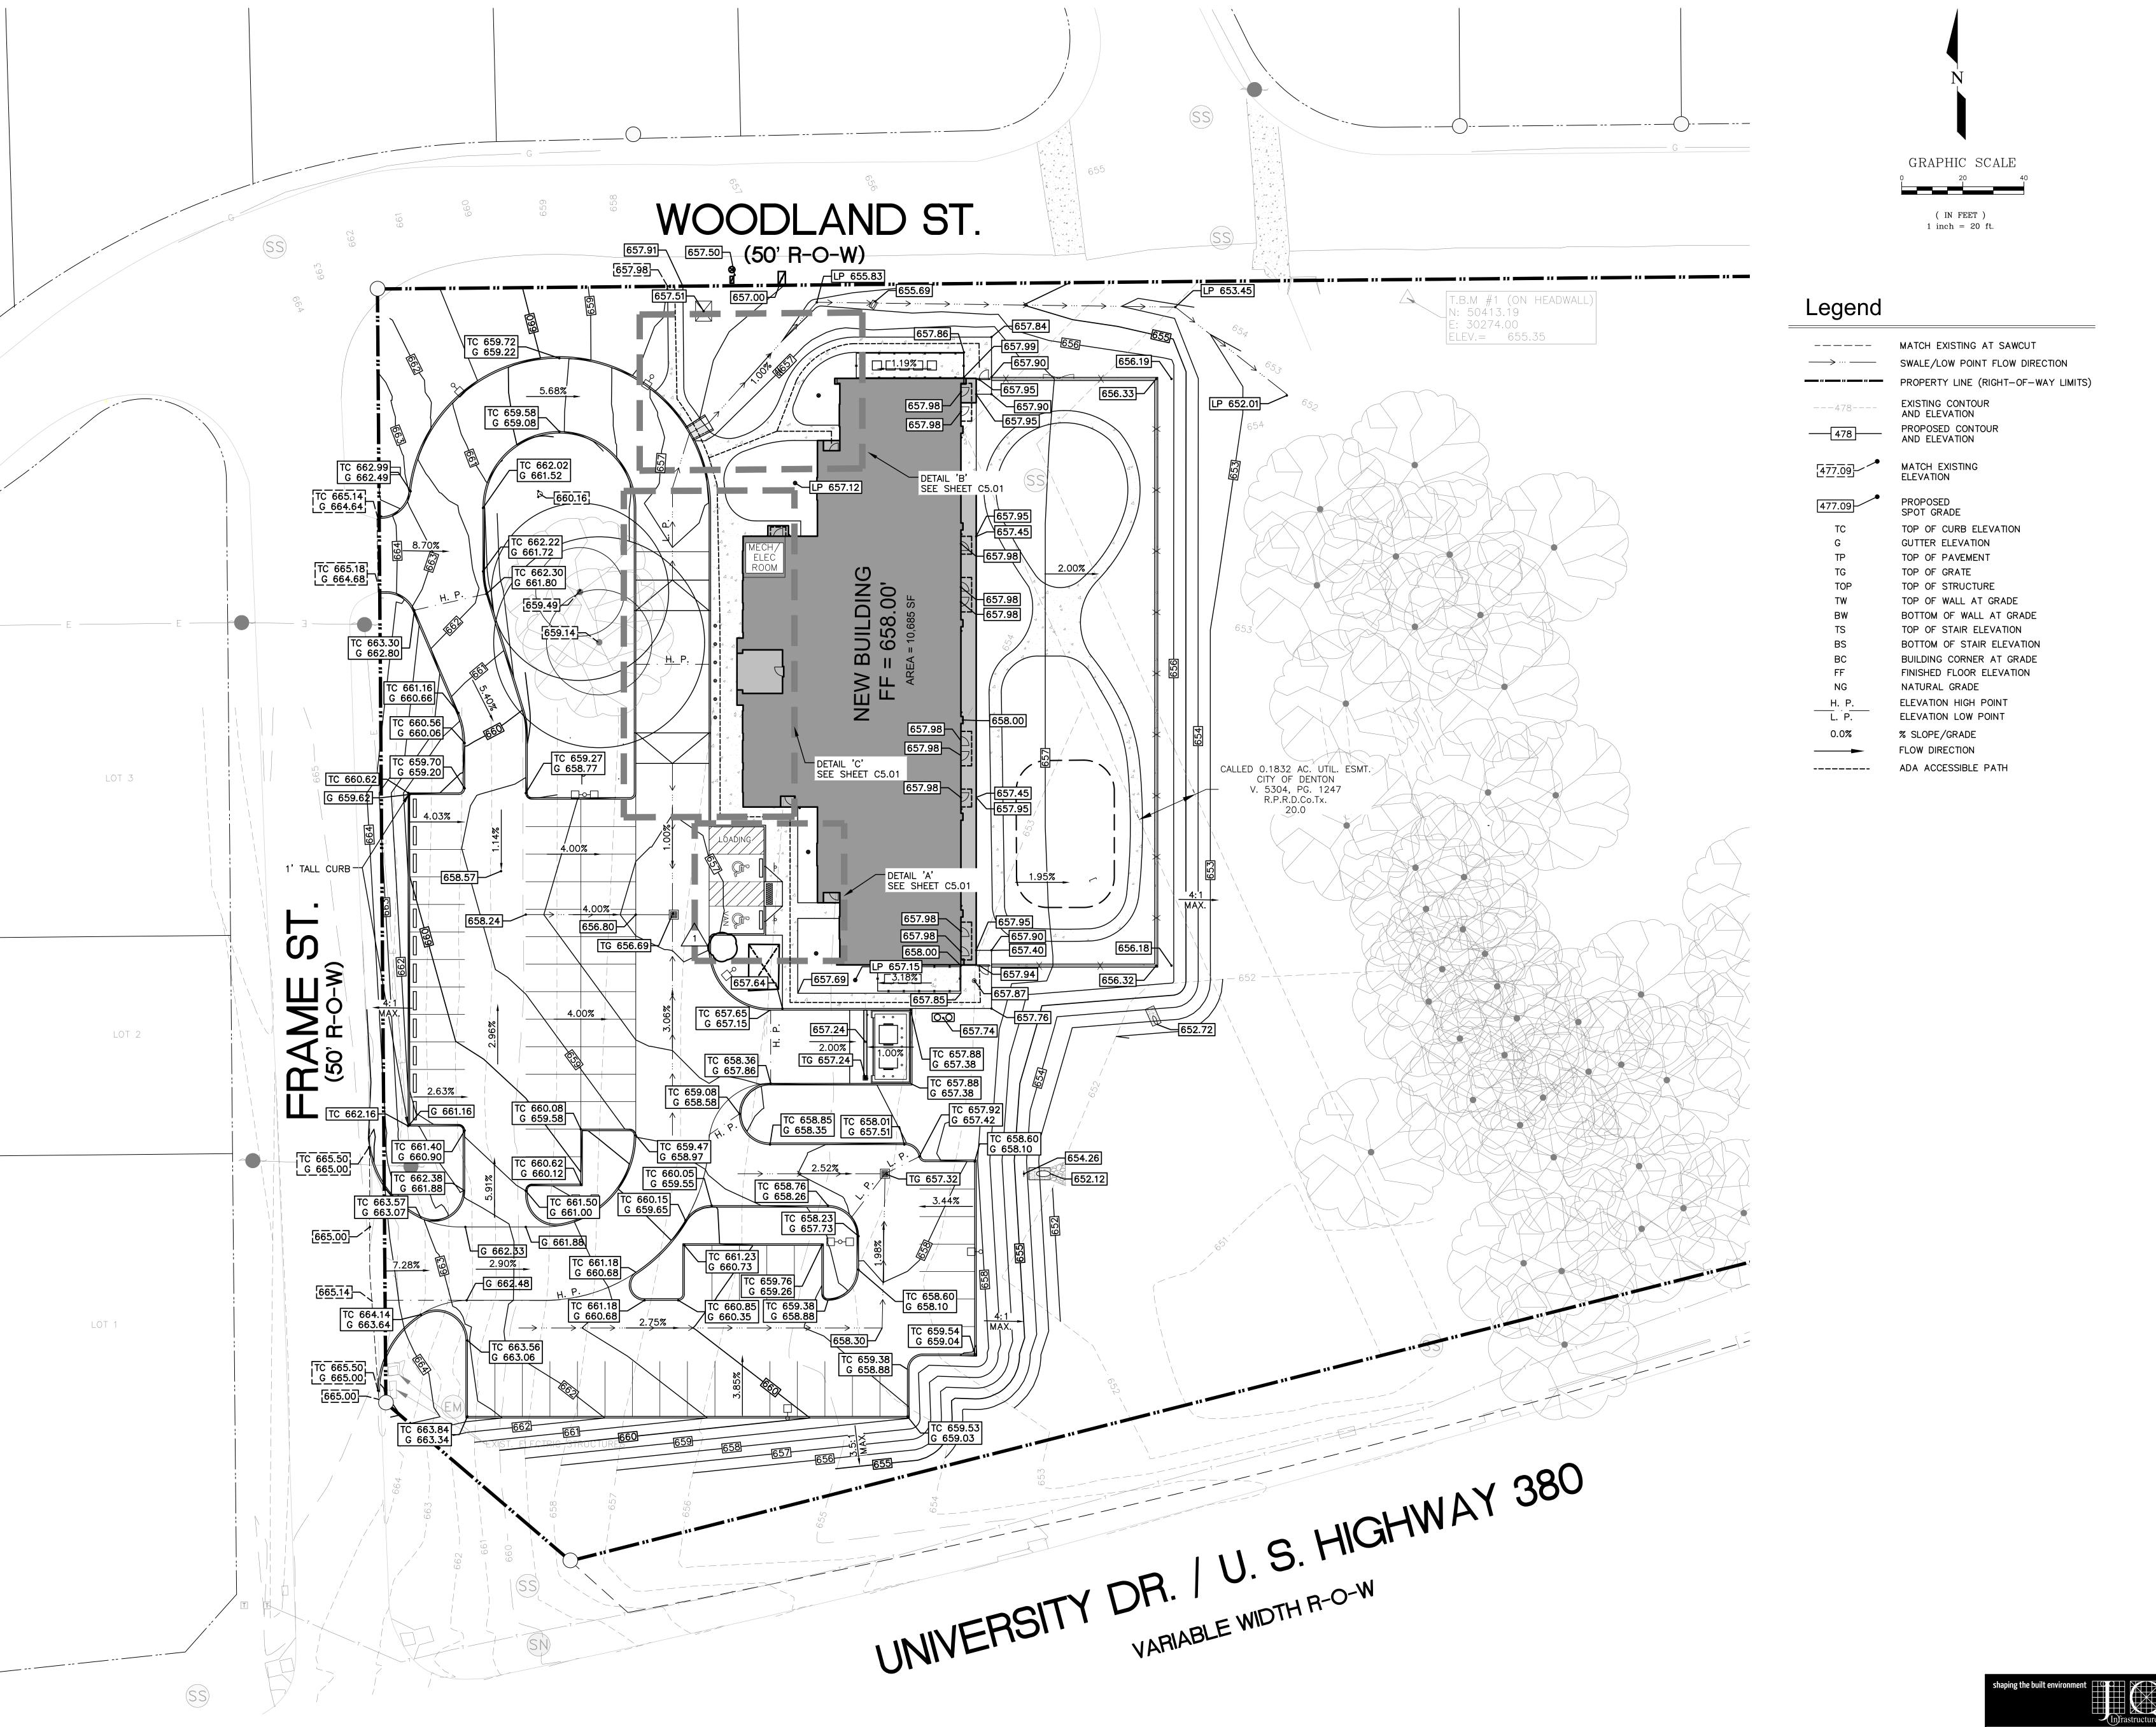



1320 Hemphill Street, Suite 40



Quality Control Designer Proj. Arch.

23-018.00

C5.00

Legend

---478---

MATCH EXISTING AT SAWCUT

EXISTING CONTOUR AND ELEVATION

PROPOSED CONTOUR AND ELEVATION

TOP OF CURB ELEVATION

TOP OF WALL AT GRADE

BOTTOM OF WALL AT GRADE TOP OF STAIR ELEVATION

BOTTOM OF STAIR ELEVATION

BUILDING CORNER AT GRADE FINISHED FLOOR ELEVATION

GUTTER ELEVATION TOP OF PAVEMENT

TOP OF STRUCTURE

TOP OF GRATE

NATURAL GRADE

% SLOPE/GRADE

FLOW DIRECTION

ELEVATION HIGH POINT

ELEVATION LOW POINT

MATCH EXISTING ELEVATION

PROPOSED SPOT GRADE


SWALE/LOW POINT FLOW DIRECTION


PROPERTY LINE (RIGHT-OF-WAY LIMITS)


23-018.00

GRADING PLAN DETAILS

C5.01

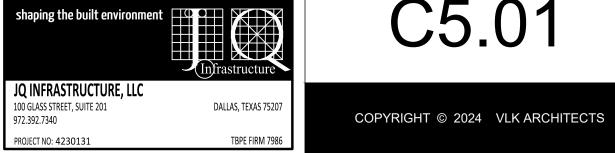

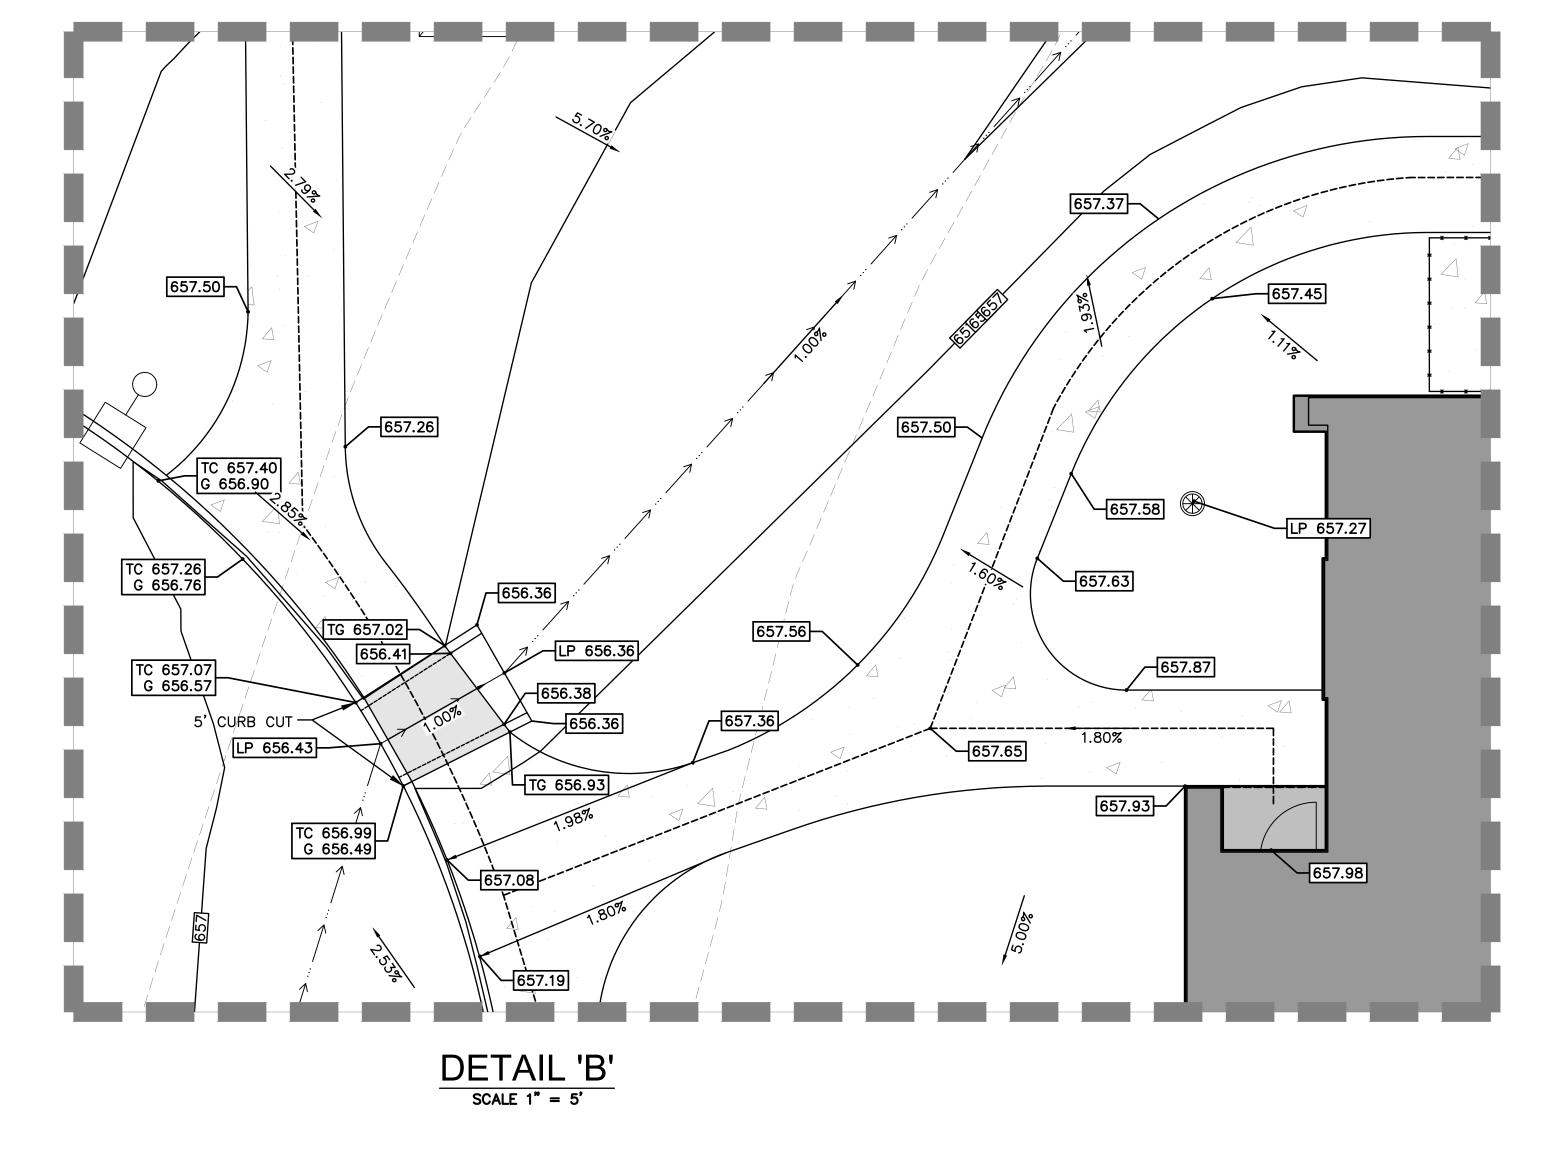

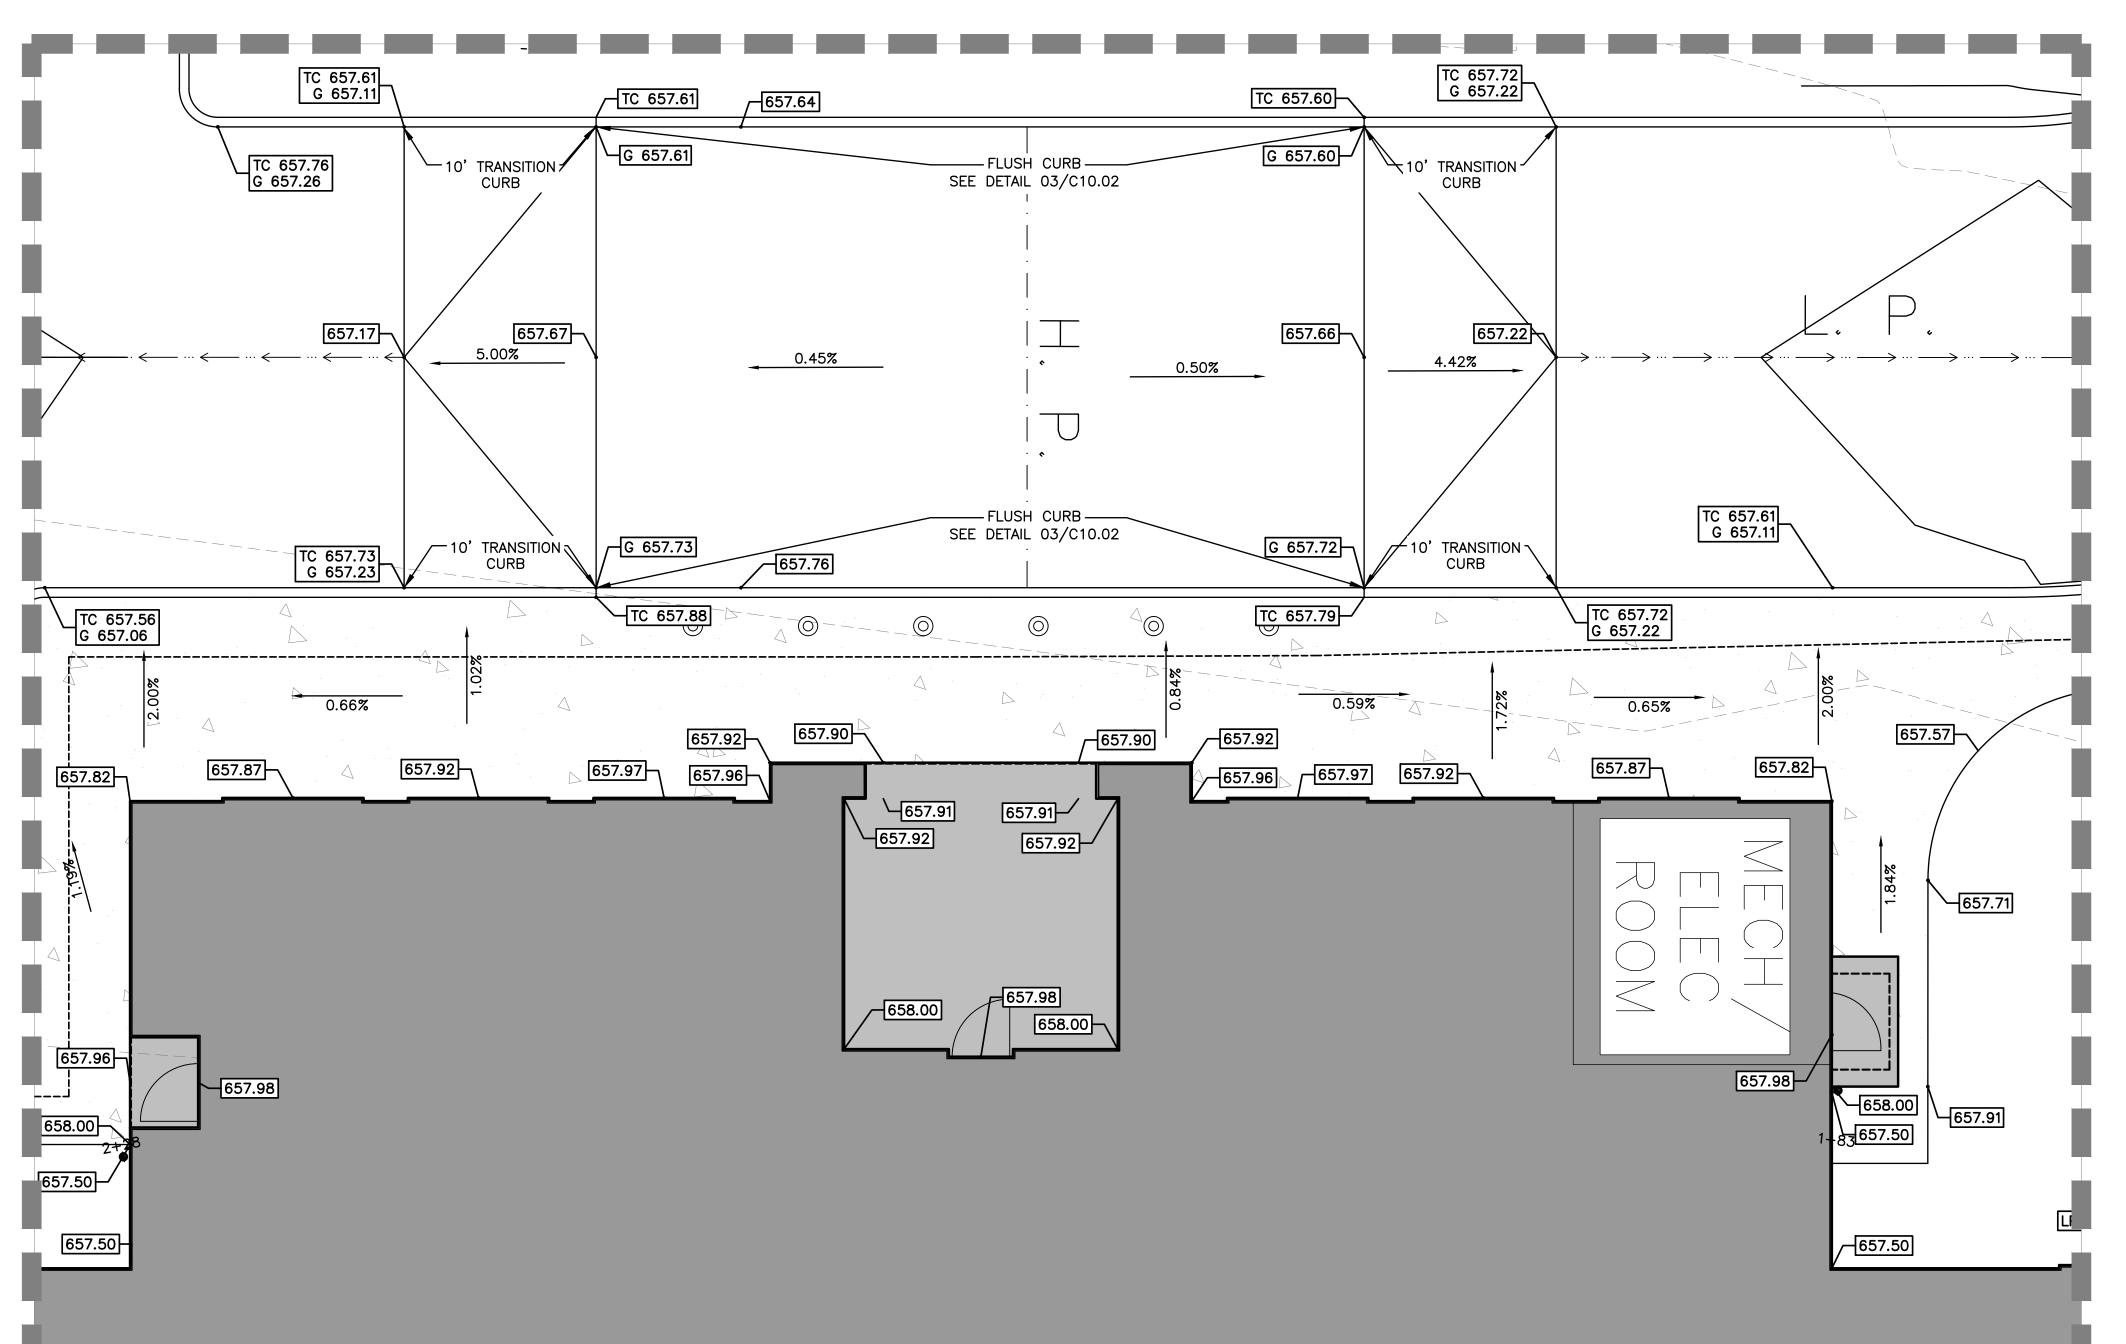

2.00%

TC 657.89 G 657.39

TC 657.74 G 657.24

 $\frac{\mathsf{DETAIL} \mathsf{'A'}}{\mathsf{SCALE} \; \mathsf{1"} = \mathsf{5'}}$

TC 657.72 G 657.22

TC 657.56 G 657.06

657.96

657.31

LP 657.20

657.50 / 657.87


657.79

657.84

657.35

LP 657.25

2.00%

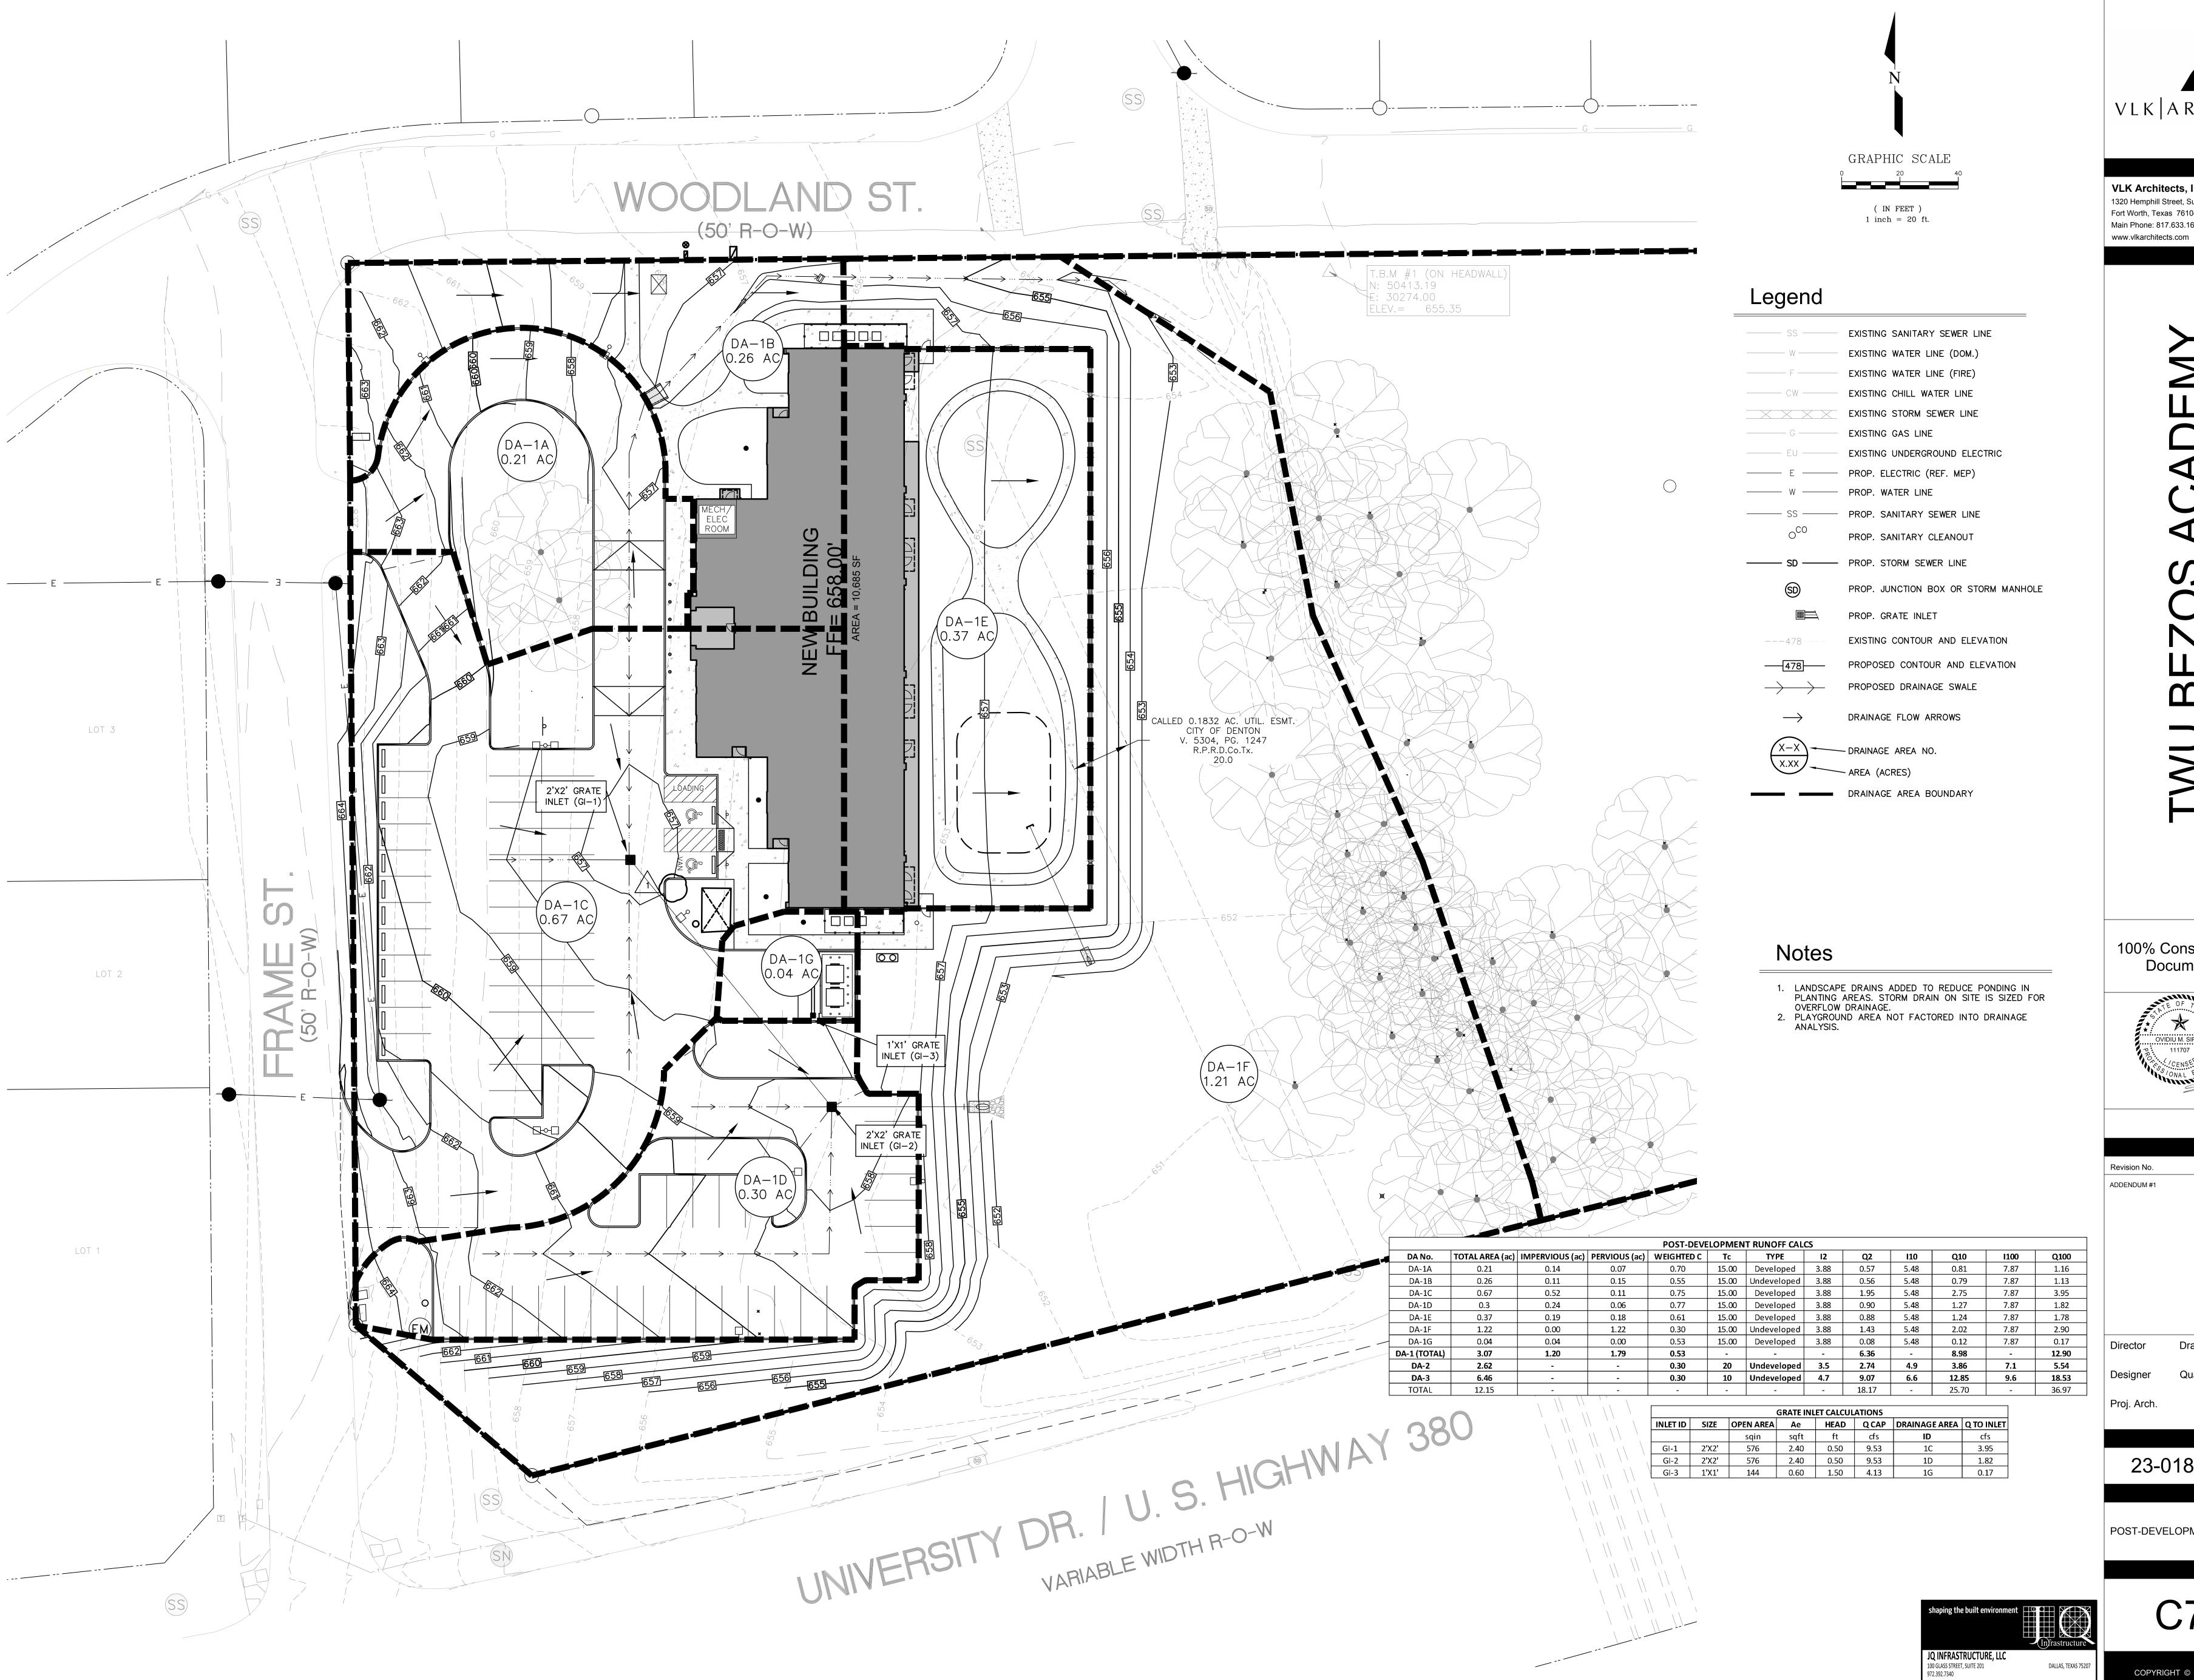



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100% Construction Documents



Revision Date

Drawn By: K.Q.

Quality Control

23-018.00

POST-DEVELOPMENT DAM

DALLAS, TEXAS 75207

TBPE FIRM 7986

PROJECT NO: 4230131

C7.00



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P/ DE

100% Construction Documents



Revision Date Revision No. 3/19/2024 ADDENDUM #1

Drawn By: K.Q. Director

Quality Control Designer Proj. Arch.

23-018.00

OVERALL UTILITY PLAN

JQ INFRASTRUCTURE, LLC 100 GLASS STREET, SUITE 201 972.392.7340

DALLAS, TEXAS 75207

TBPE FIRM 7986

C8.00

1320 Hemphill Street, Suite 400 Fort Worth, Texas 76104 Main Phone: 817.633.1600 www.vlkarchitects.com

GRAPHIC SCALE

(IN FEET)1 inch = 20 ft.

100% Construction Documents



ADDENDUM #1

23-018.00

EROSION CONTROL PLAN & DETAILS

C9.00

REF. LANDSCAPE PLANS
FOR TREE PROTECTION,
DEMOLITION ADJACENT TO
TREES AND NOTES FOR
CONTRACTOR.

JQ INFRASTRUCTURE, LLC 100 GLASS STREET, SUITE 201 972.392.7340

PROJECT NO: 4230131

DALLAS, TEXAS 75207

TBPE FIRM 7986

P/ DE

Drawn By Author


Director Approver Designer **Quality Control** Designer Proj. Arch. Checker


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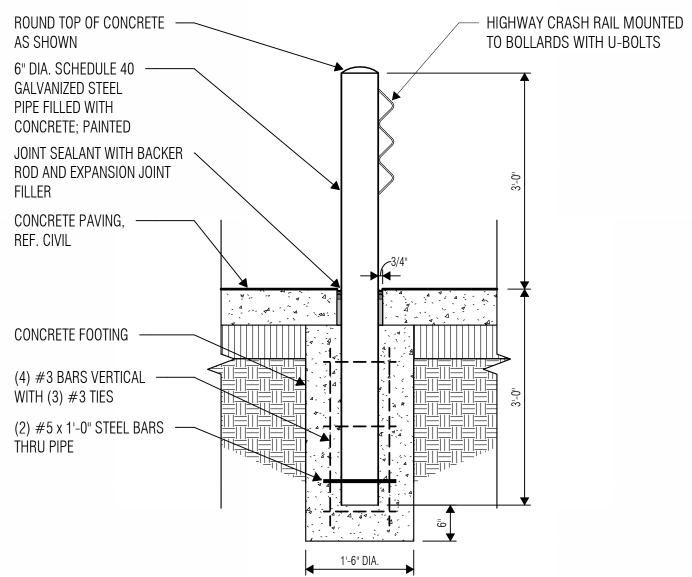
23-018.00 SHEET TITLE


SITE DETAILS

A1.12



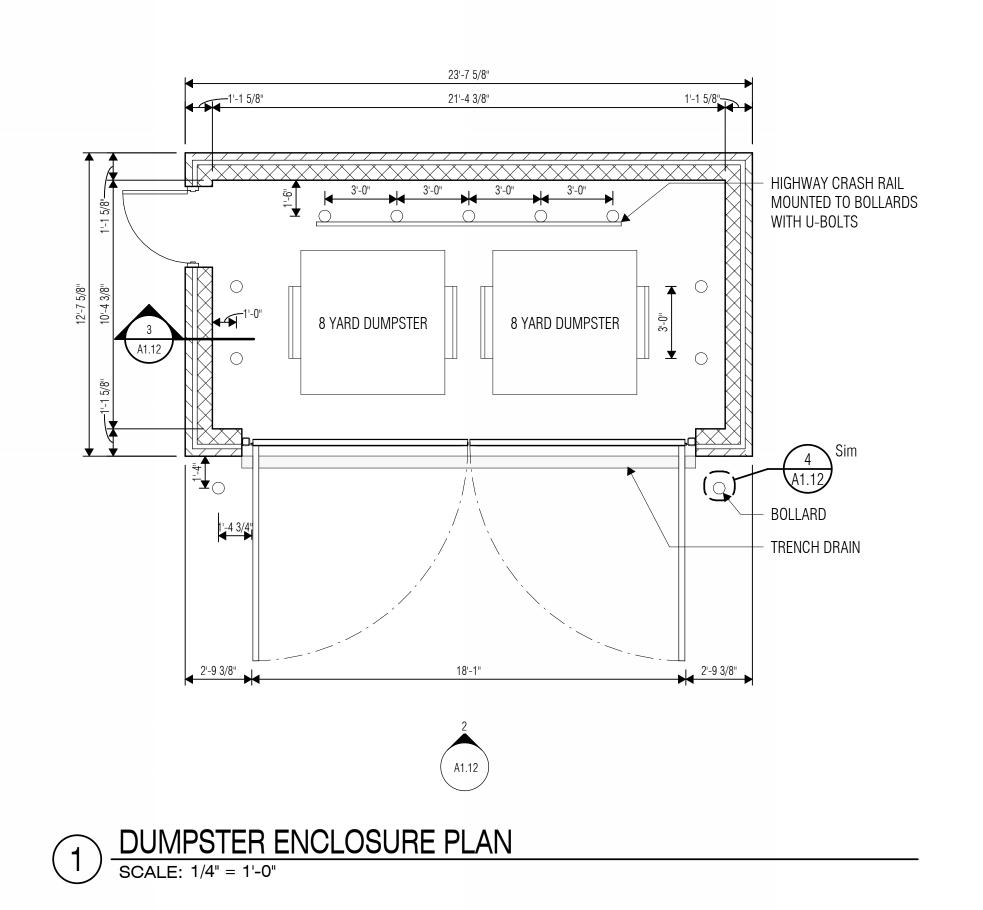

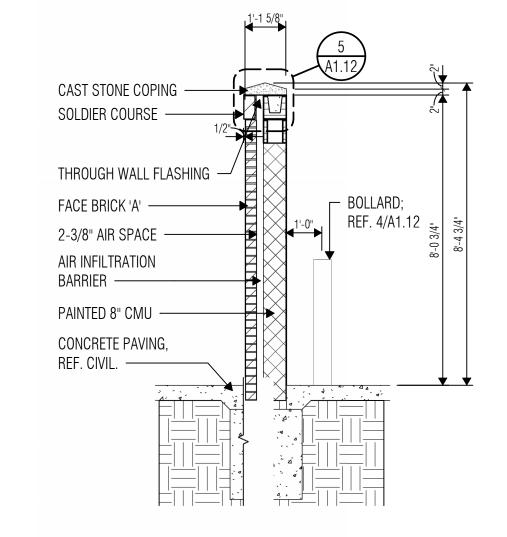

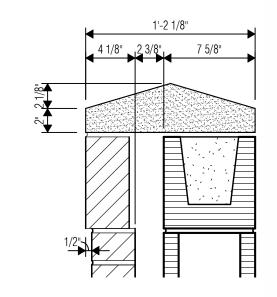


3 DUMPSTER WALL SECTION


SCALE: 3/8" = 1'-0"

BOLLARD DETAIL


SCALE: 3/4" = 1'-0"

DUMPSTER WALL SECTION - CAST STONE CAP SCALE: 1 1/2" = 1'-0"

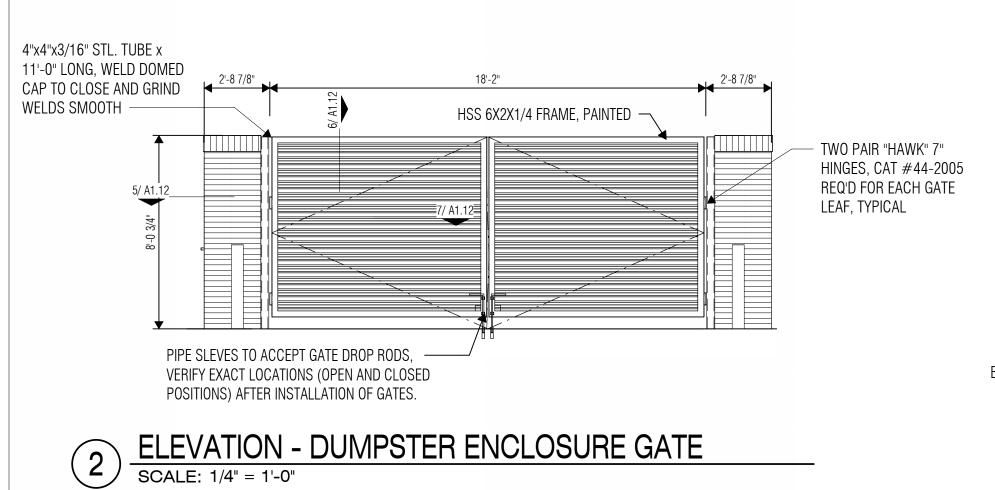

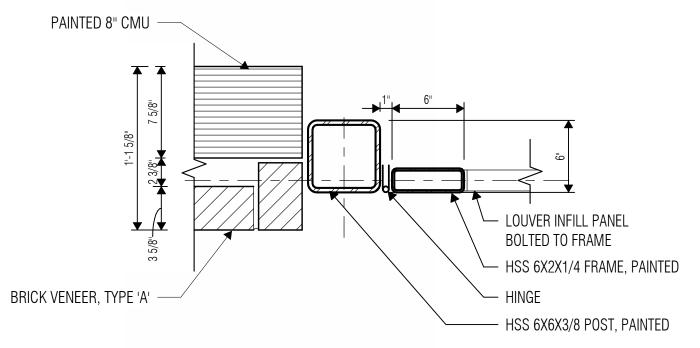


VEHICLE SWING GATE - JAMB DETAIL

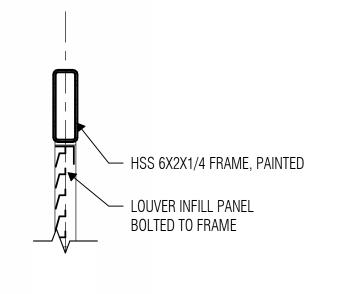





7 VEHICLE SWING GATE - HEAD DETAIL
SCALE: 1 1/2" = 1'-0"

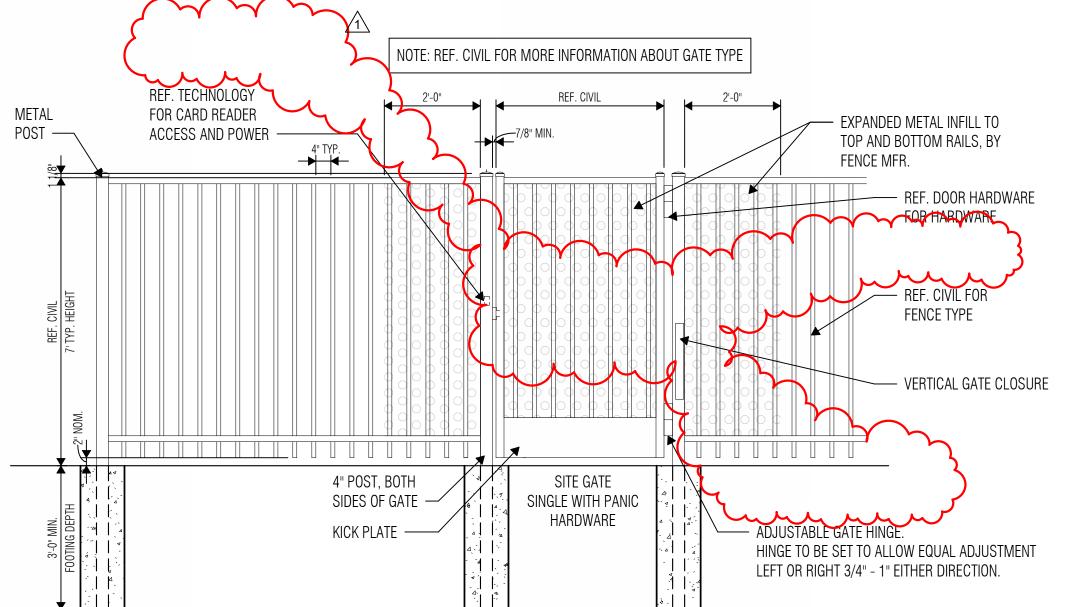

DECORATIVE FENCE AND GATE DETAIL


SCALE: 1/2" = 1'-0"

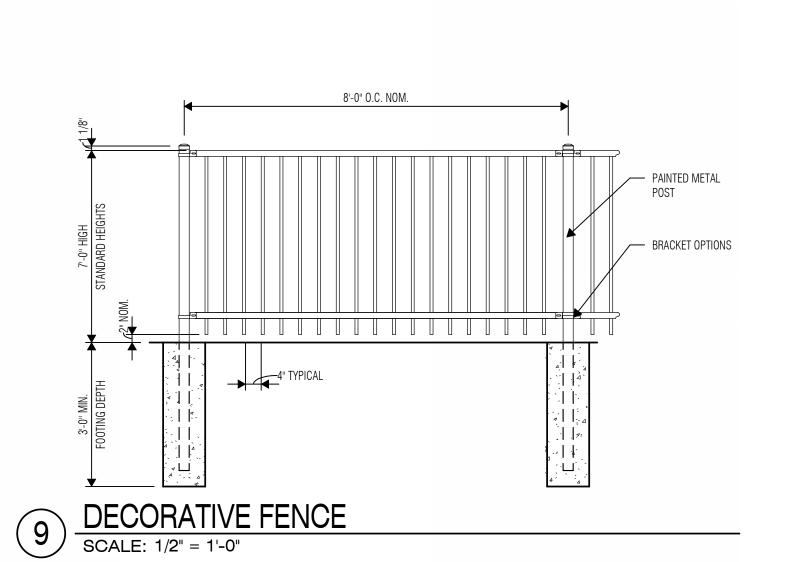

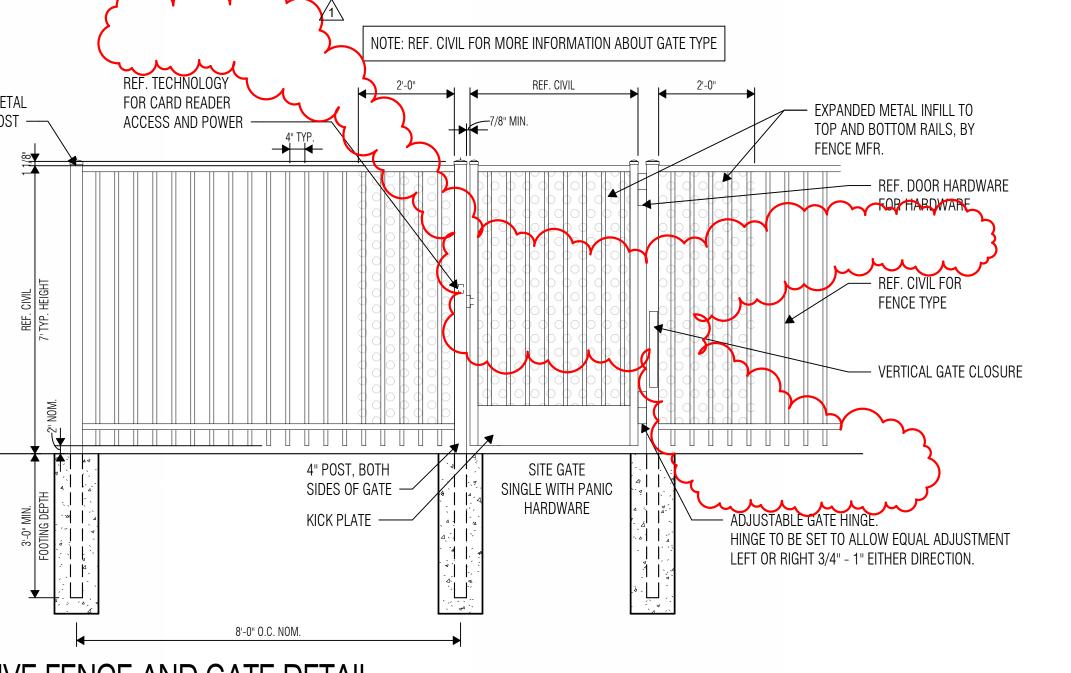

VEHICLE SWING GATE - CENTER DETAIL SCALE: 1 1/2" = 1'-0"

NOTE: PLACE EXPANSION JOINT AT EACH FENCE POST AND EVERY 50 FEET

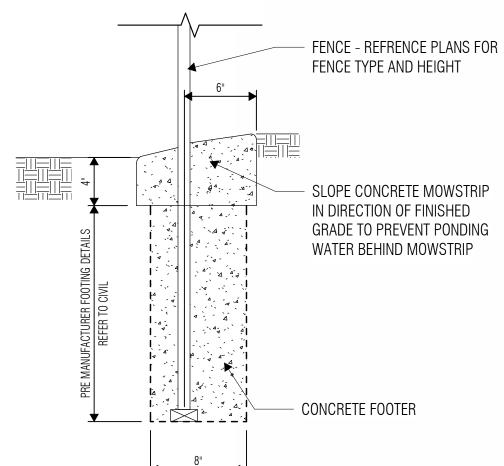

LOUVER INFILL PANEL

─ HSS 6X2X1/4 FRAME, PAINTED

— HANDLE WELDED TO FRAME

BOLTED TO FRAME

FENCE W/ MOWSTRIP
SCALE: 1 1/2" = 1'-0"

SHEET NO.

Director Drawn By
Approver Author
Designer Quality Control
Designer
Proj. Arch.
Checker


PROJECT NO. 23-018.00


SHEET TITLE

FLOOR PLAN / ATTIC PLAN

SHEET NO.

A2.11

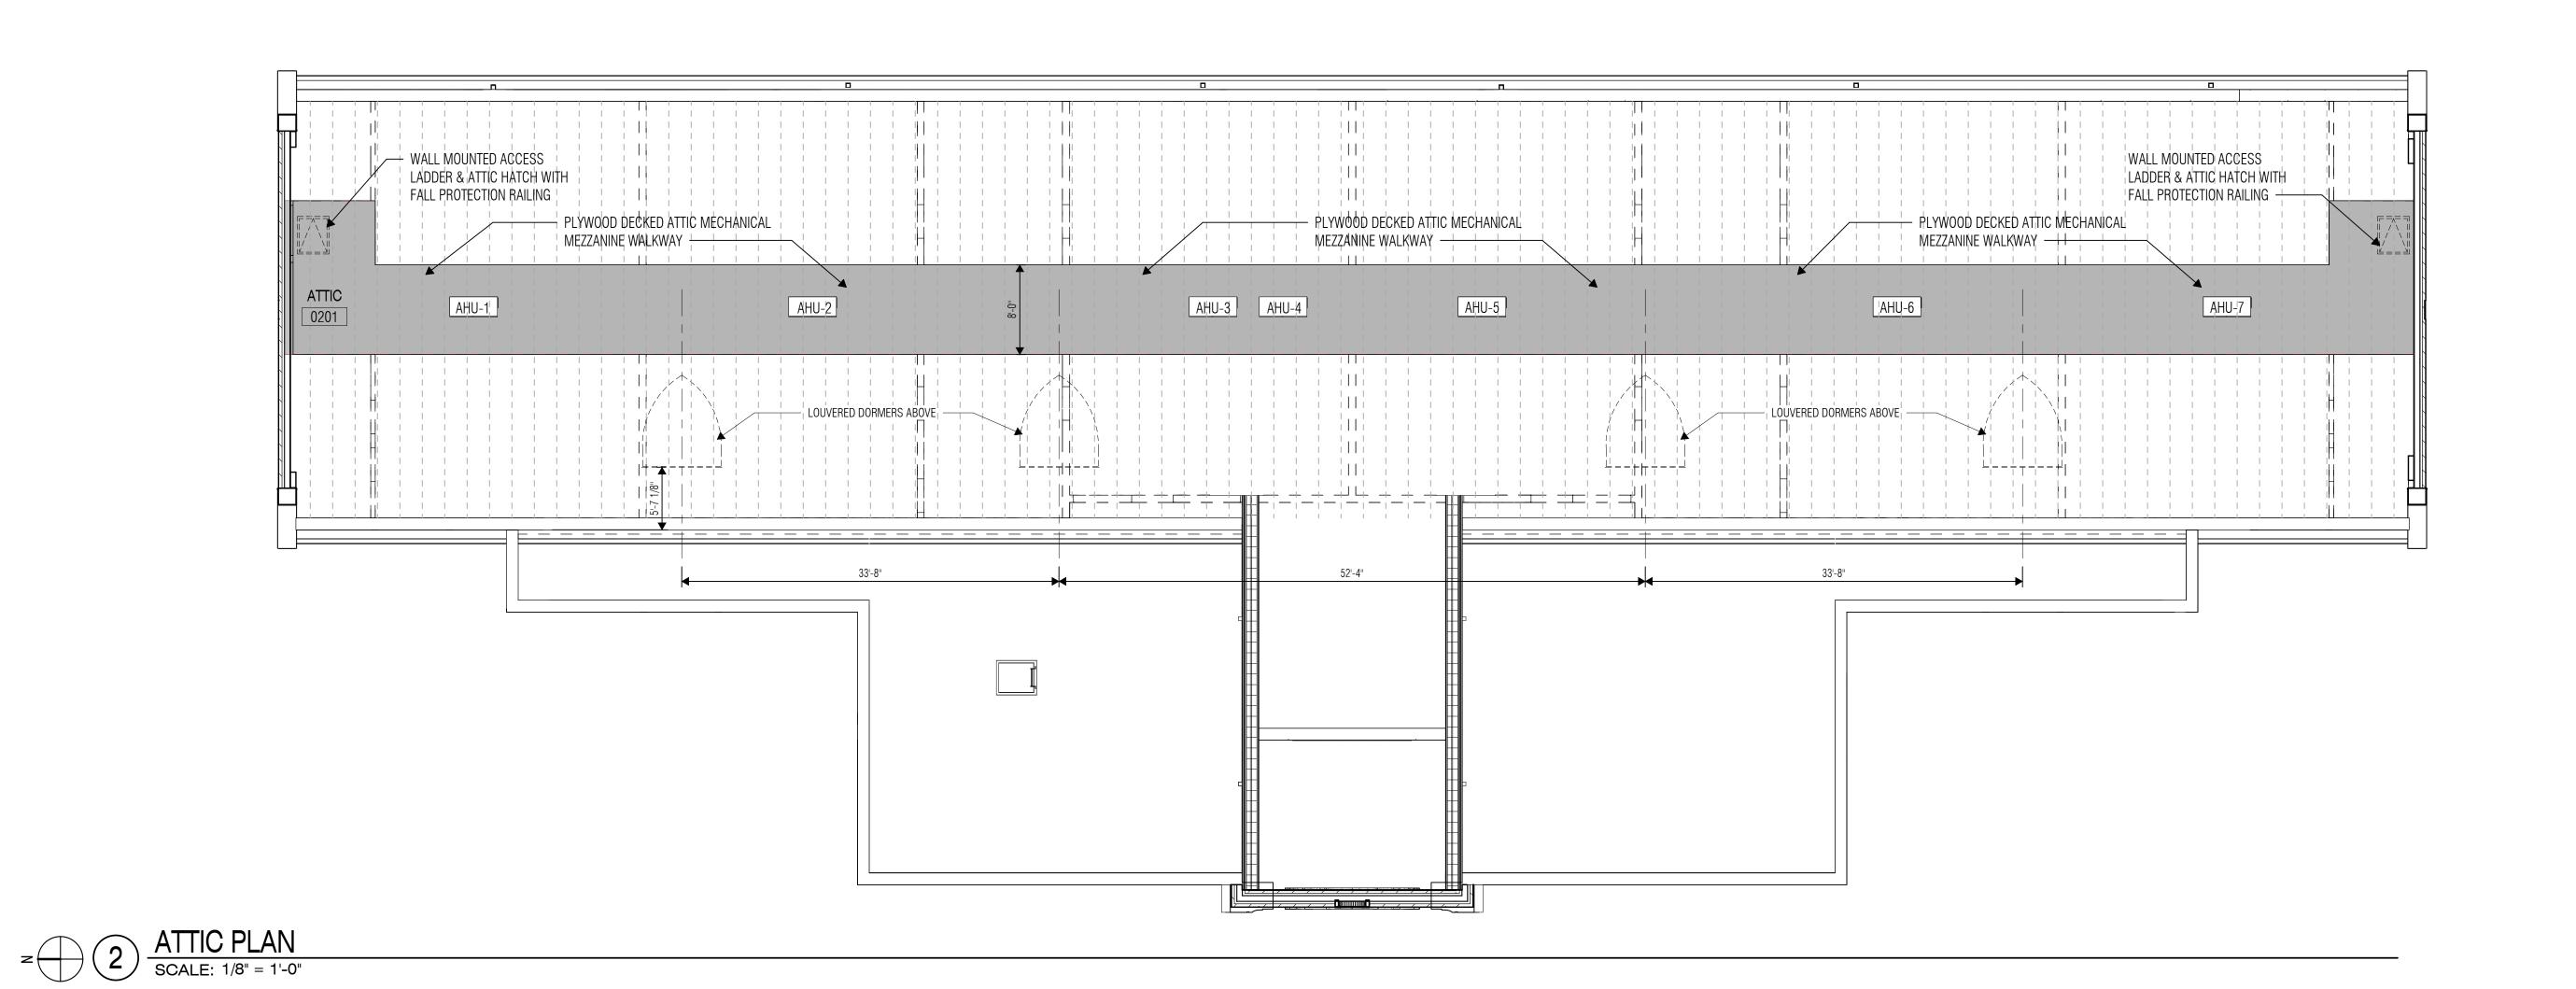

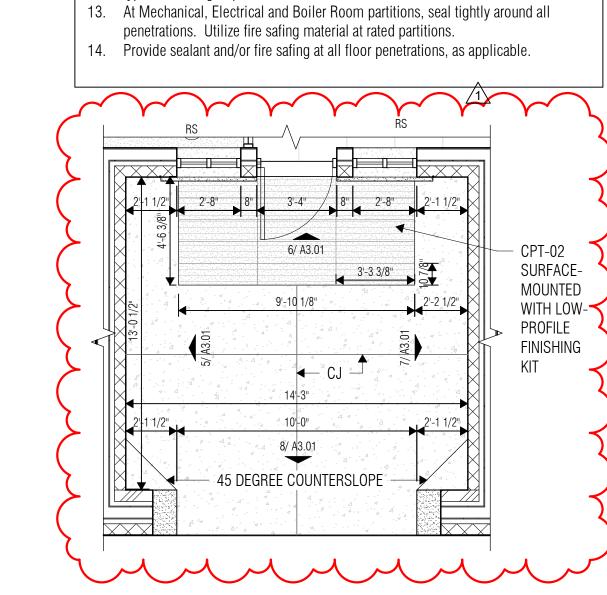

FLOOR PLAN NOTES

1. Primary Ground Level floor elevation is 658.00' (Mean Sea Level), which equals

Dimensions on Floor Plans are to face of stud or CMU unless noted otherwise. Coordinate the location of electrical devices with casework, millwork, lockers, etc. Any electrical device that is not properly coordinated shall be relocated at no

Exterior wall construction is identified on the Wall Sections. Refer to the A4-

Refer to Exterior Elevation Notes for control joint requirements at all inside corners

Refer to Detail 3/A0.31 for Typical Door Maneuvering Clearances. All new doors

comply with these requirements, request clarification from the Architect prior to

shall meet the requirements of that detail. If any door is found that does not

Refer to Sheet A2.21 for Typical Gypsum Board Control Joint Details at all CFS

10. Refer to Sheet A2.21 for Typical Partition Penetration Details, including pipe,

12. Provide minimum 2 X 6 fire-retardant treated wood blocking in both new and existing stud walls and partitions, at mounting locations for wall-mounted accessories, handrails, casework, markerboards, tackboards, folding partitions, toilet partitions, and all other wall-mounted items. Refer to Sheet A3.31 for

to 100'-0" datum.

additional cost.

of masonry veneer.

construction.

series sheets for Wall Sections.

Refer to Sheet A2.21 for Partition Types.

and light-gage steel stud partition openings.


conduit and ductwork penetrations.

Interior partitions are Type "P1" unless noted otherwise.

11. Refer to Exterior Elevations for exact locations of downspouts.

typical blocking requirements at various conditions.

3 ENLARGED PLAN - COVERED PORCH SCALE: 1/4" = 1'-0"

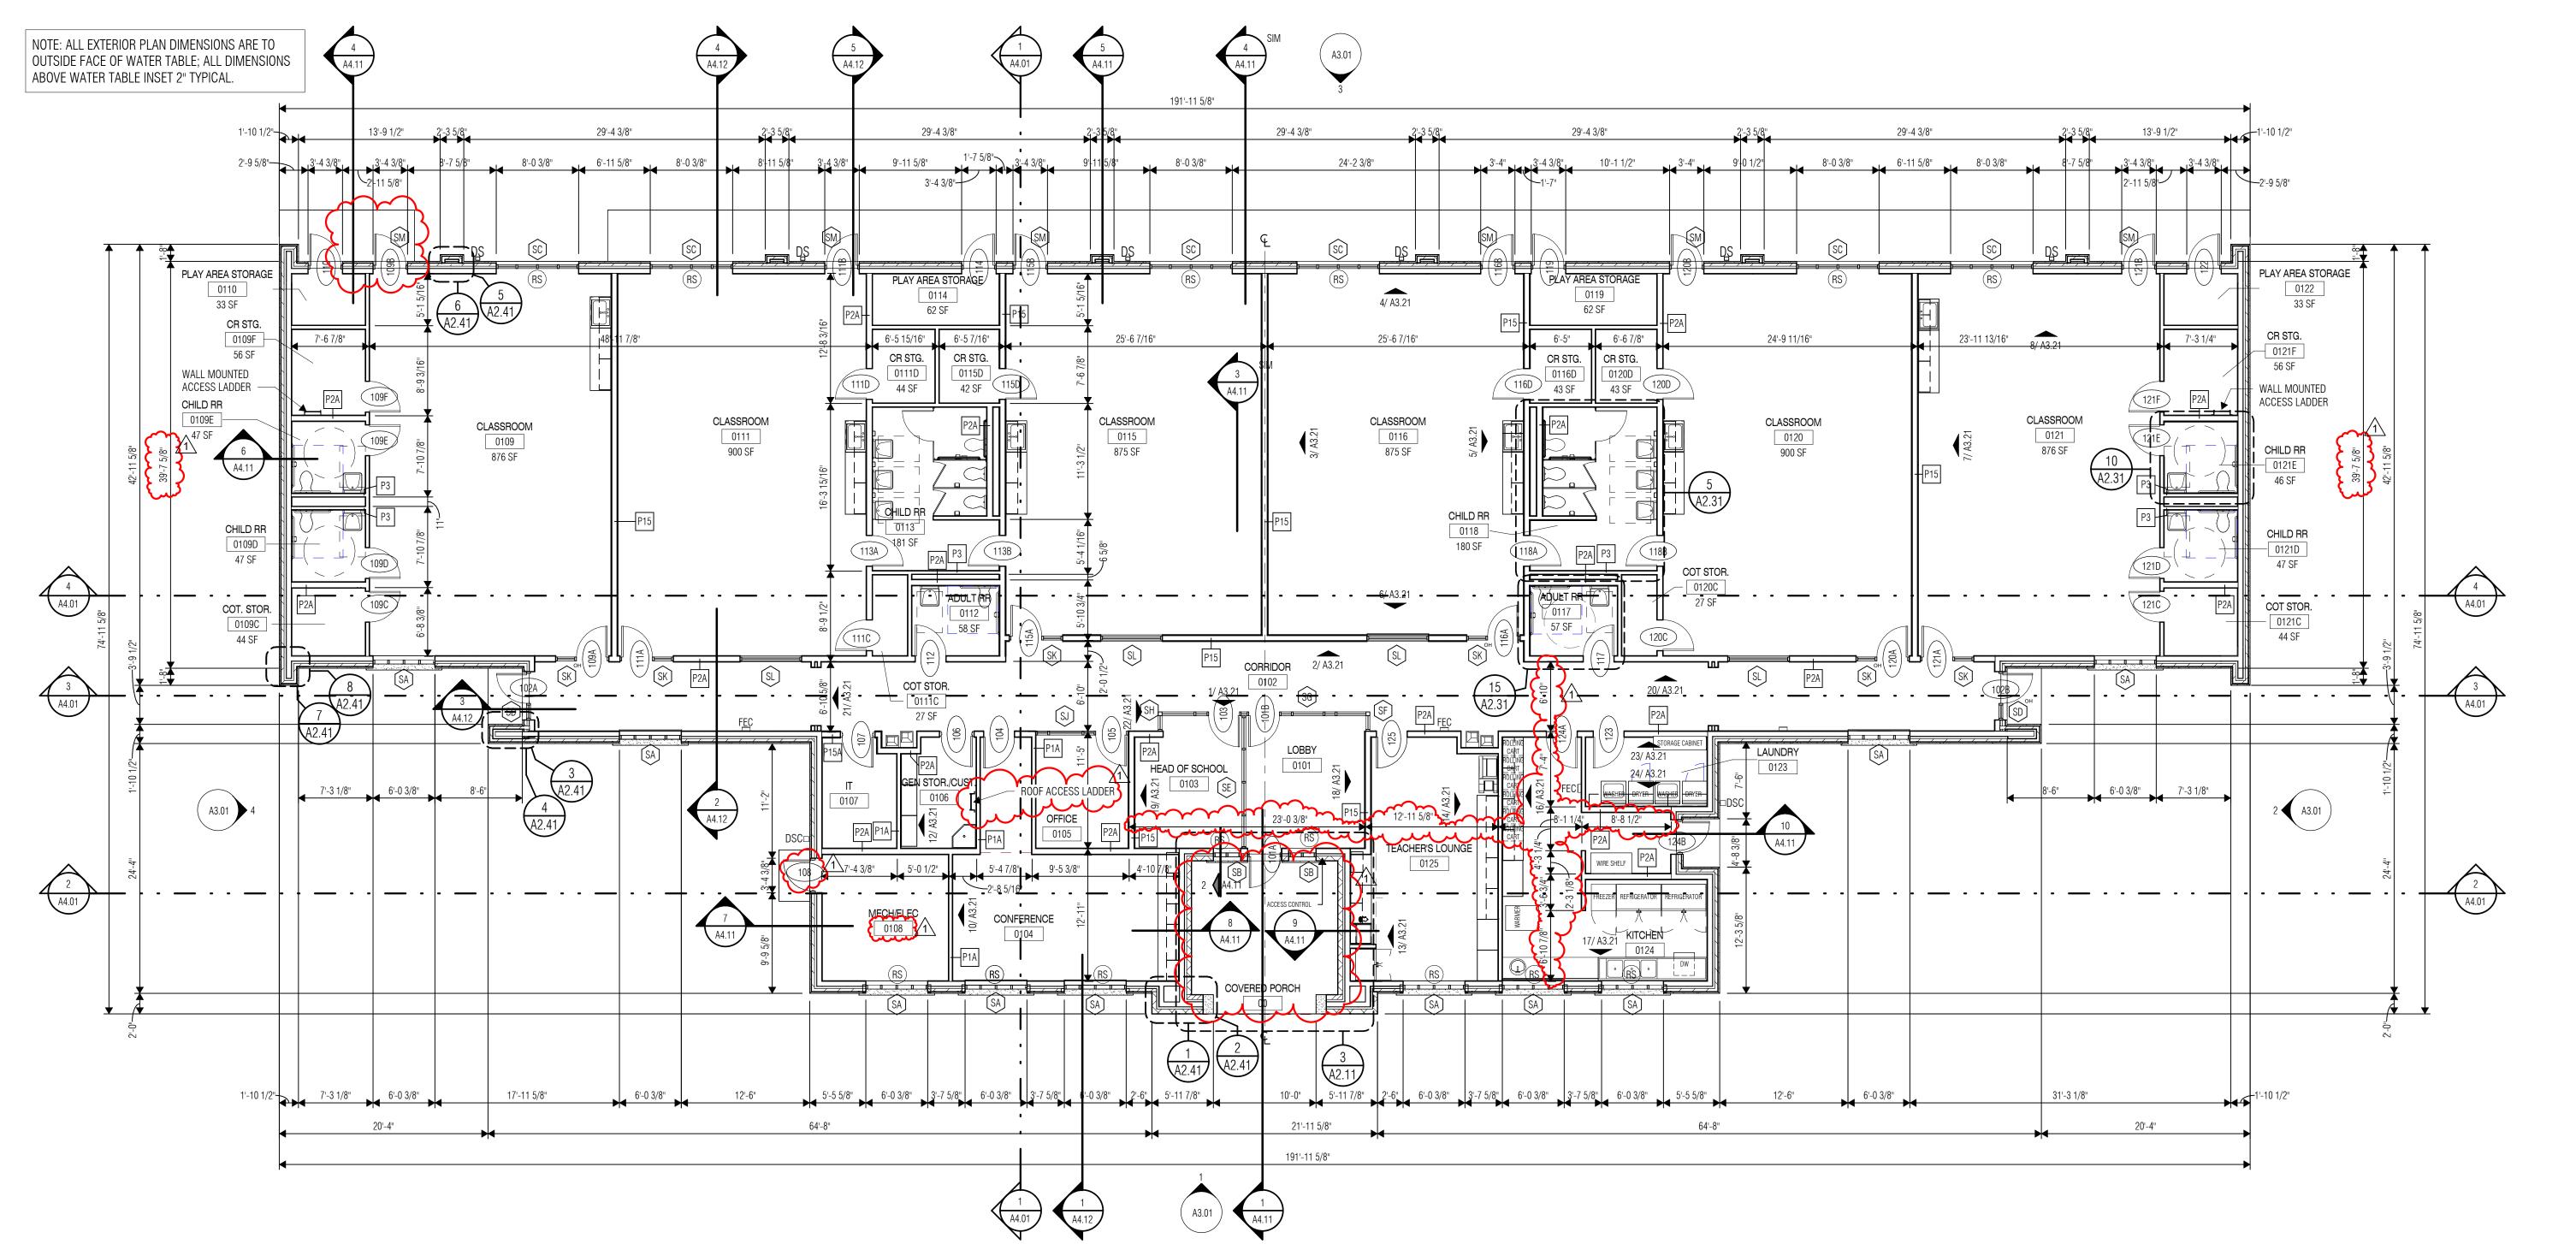

<u>Р</u>

03-19-2024

1 Addendum 01

Proj. Arch.


Checker PROJECT NO.

23-018.00 SHEET TITLE

ENLARGED TOILET PLANS AND ELEVATIONS

SHEET NO.


A2.31

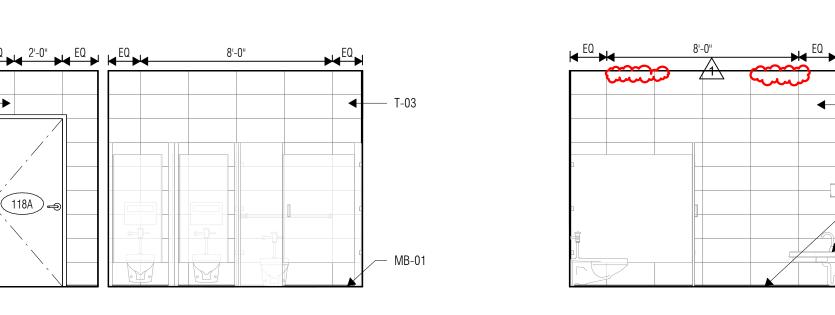




TOILET TISSUE DISPENSER -


TOILET PARTITION ---

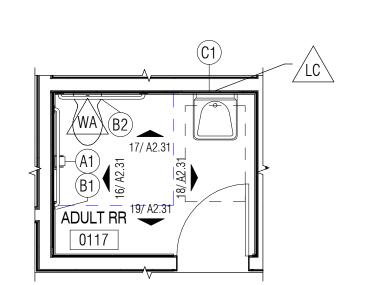

TYPICAL ADULT SINGLE RR - 0117

SCALE: 1/4" = 1'-0"

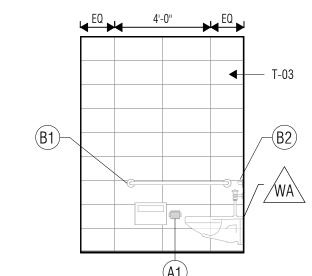

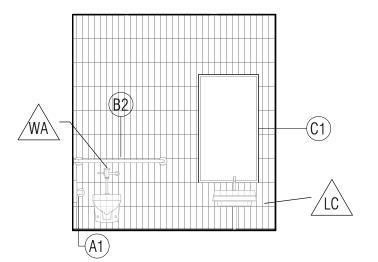



TYPICAL ADULT SINGLE RR - 0117 NORTH


SCALE: 1/4" = 1'-0"


TYPICAL ADULT SINGLE RR - 0117 EAST

SCALE: 1/4" = 1'-0"

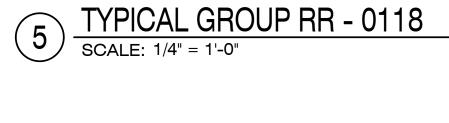


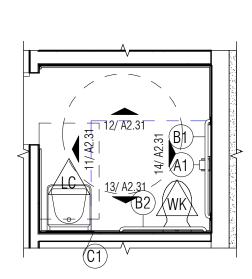

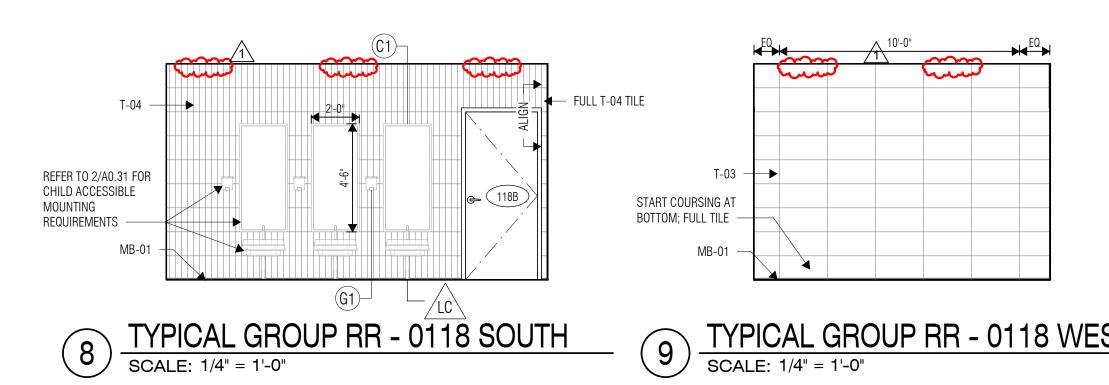

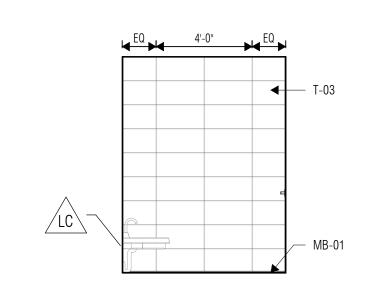





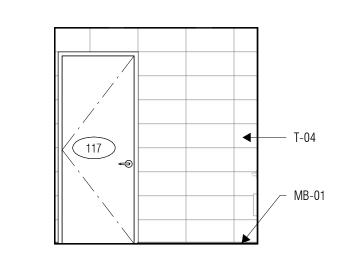


19 TYPICAL ADULT SINGLE RR - WEST SCALE: 1/4" = 1'-0"

TYPICAL SINGLE RR - CHILD SCALE: 1/4" = 1'-0"

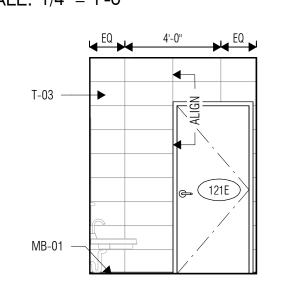

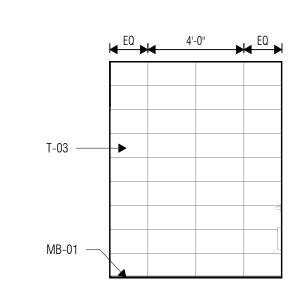


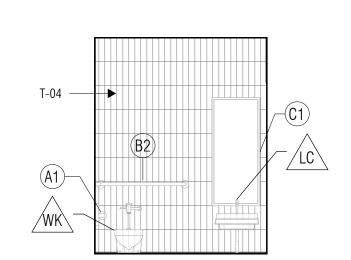

REFER TO 2/A0.31 FOR

CHILD ACCESSIBLE MOUNTING

REQUIREMENTS

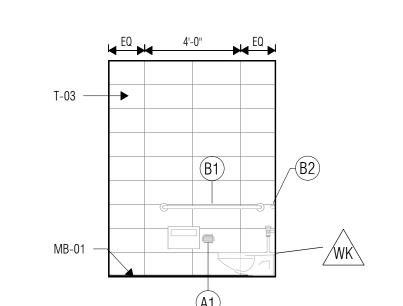

TYPICAL CHILD SINGLE RR - 0121E SOUTH

SCALE: 1/4" = 1'-0"

(11)	TYPICAL CHILD SINGLE RR - 0121E NORTH SCALE: 1/4" = 1'-0"
	SCALE: 1/4" = 1'-0"

ACCESSIBLE TOILET ROOM





FINISH WALL LINE —

SANITARY NAPKIN

DISPOSAL (WHEN

SCHEDULED) ——

TOILET SEAT COVER

DISPENSER (WHEN

SCHEDULED) -

	TOILET PLUMBING FIXTURE	LEGEND	
MARK	PLUMBING FIXTURE ITEM	MOUNTING HEIGHT (A.F.F.)	NOTES
L	LAVATORY - STANDARD	MATCH ACCESS.	
LA	LAVATORY- ADULT ACCESSIBLE	34" TO RIM	4
LC	LAVATORY- CHILD ACCESSIBLE	31" TO RIM	4
EC	ELECTRIC WATER COOLER (HIGH/LOW UNIT) - CHILD ACCESSIBLE	36" TO LOW SPOUT	4
WA	WATER CLOSET - ADULT ACCESSIBLE	18" TOP OF SEAT	3
WK	WATER CLOSET - CHILD (PRE-K) STANDARD & ACCESSIBLE	12" TOP OF SEAT	3
desi 2. Refe	: e that the architectural marks in this legend may differ from the gnations in the MEP Plumbing Legend. erence MEP Plumbing drawings and legends for additional fixtures. unting height at floor-mounted fixture might vary slightly based on actual	ABBREVIATIONS: ACCESS. = ACCESTOR STD. = STAN	ESSIBLE NDARD

Mounting neight at floor-mounted fixture might vary slightly based on actual	
product selected.	
Mounting height is based on maximum allowable and cannot be exceeded.	
The TAS required kneespace of 27" is not provided using this mounting	
height; ensure spout is located 3-1/2" max. from front edge/bumper as	
required for parallel approach per the TAS.	
	product selected. Mounting height is based on maximum allowable and cannot be exceeded. The TAS required kneespace of 27" is not provided using this mounting height; ensure spout is located 3-1/2" max. from front edge/bumper as

6. For standard urinals at child-only facilities, provide 20" to rim.

See INDEX Sheet for additional abbreviations

ENLARGED FLOOR PLAN NOTES

- Dimensions on Enlarged Floor Plans are to face of wall finish material unless
- Dashed lines shown on Enlarged Floor Plans indicate accessibility requirements Install all accessible plumbing fixtures and toilet accessories in accordance with
- the Texas Accessibility Standards and as indicated on Sheets A0.31 and A2.31. Install all non-accessible plumbing fixtures and toilet accessories at
- manufacturers' recommended mounting heights, unless noted otherwise. Refer to Toilet Accessory Legend on Sheet A2.31 for Toilet Accessory
- information and mounting heights. At accessible toilet compartments, install water closets with the centerline of fixture at 1'-5" off the side wall finish material. At both ambulatory-accessible and non-accessible toilet compartments, install water closets at the centerline of the compartment.
- Install hand-operated flush controls for wheelchair accessible water closets on the open side of the water closet. Flush control assembly shall not extend above grab bar, and top of flush control assembly shall be held a minimum of 1-1/2" below the grab bar.

TOILET & SHOWER NOTES

non-accessible plumbing fixtures and toilet accessories at manufacturers'

At accessible toilet rooms and compartments, install water closets with the

centerline of fixture at 1'-5" off the side wall finish material. At both ambulatory

accessible and non-accessible toilet compartments, install water closets at the

Install hand-operated flush controls for wheelchair accessible water closets on

4. At accessible toilet rooms and wheelchair accessible toilet compartments for

child-only use at Pre-K facilities with 12" high water closets, install water

closets with the centerline of fixture at 1'-0" off the side wall finish material.

the open side of the water closet. Flush control assembly shall not extend above grab bar, and top of flush control assembly shall be held a minimum of

recommended mounting heights, unless noted otherwise.

center of the compartment.

1-1/2" below the grab bar.

Install all accessible plumbing fixtures and toilet accessories in accordance with the Texas Accessibility Standards, and as indicated on this sheet. Install all

- Provide pipe protection for all exposed piping at both accessible and nonaccessible lavatories.
- Floor drains are indicated for location purposes only. Refer to Plumbing Drawings for floor drain sizes and plumbing information.

60" ACCESSIBLE	56" MIN.
TURNING SPACE	LAVATORY, WHERE OCCURS
WATER CLOSET CLEARANCE	PROVIDE COAT/ROBE HOOK IN ROOM FINISHED WALL SURFACE
	42" GRAB BAR LOCATE FLUSH VALVE HANDLE ON OPEN SIDE OF W.C/.
60" MIN.	SANITARY NAPKIN DISPOSAL (WHEN SCHEDULED) WATER CLOSET
	TOILET TISSUE DISPENSER Q FIXTURE FIXTURE
	48" GRAB BAR 7"-9"
	TOILET SEAT COVER DISPENSER (WHEN SCHEDULED)


T-03 —



5'-1" CLEAR FINISH DIMENSION


WATER CLOSET -

— TOILET PARTITION —

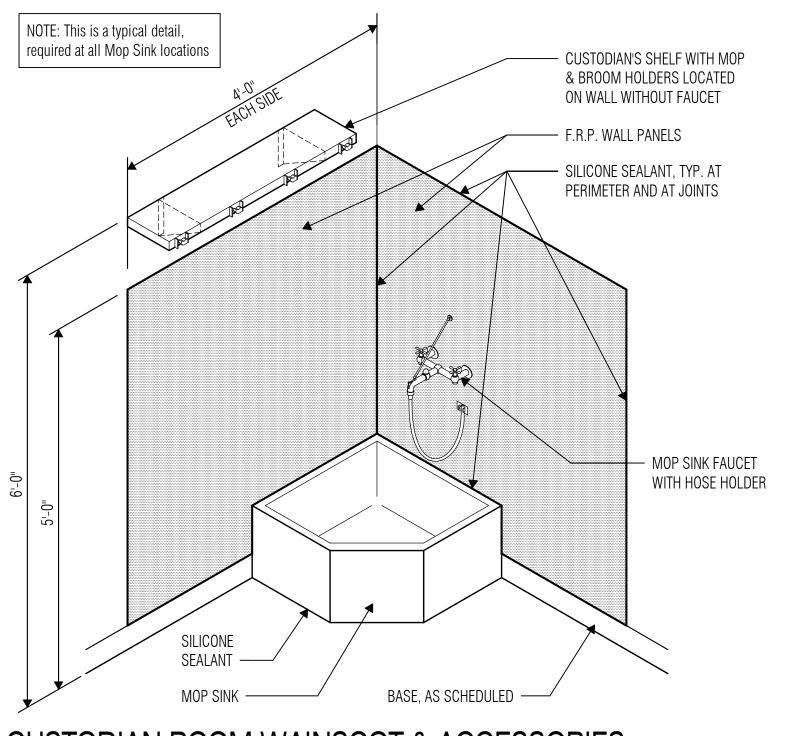

42" MIN. — TOILET COMPARTMENT DOOR MANEUVERING CLEARANCE FINISH WALL LINE -34" DOOR (32" MIN. 5'-1" CLEAR FINISH DIMENSION CLEAR OPENING) 42" GRAB BAR —— LOCATE FLUSH VALVE HANDLE ON OPEN SIDE OF W.C. — WATER CLOSET -SANITARY NAPKIN ____ Ç <u>Fixture</u> _ 9" HIGH x 6" DEEP DISPOSAL (WHEN MINIMUM TOE CLEARANCE | SCHEDULED) — TO BE PROVIDED BEYOND COMPARTMENT-SIDE FACE DISPENS∉R OF PARTITION ON MIN. TWO SIDES OF STALL — NOTE: PROVIDE 12" HIGH x 6" DEEP TOILET PARTITION $\stackrel{}{\longrightarrow}$ TOILET SEAT COVER DISPENSER $\boxed{8"}$ TOE CLEARANCE FOR CHILDREN (WHEN SCHEDULED)



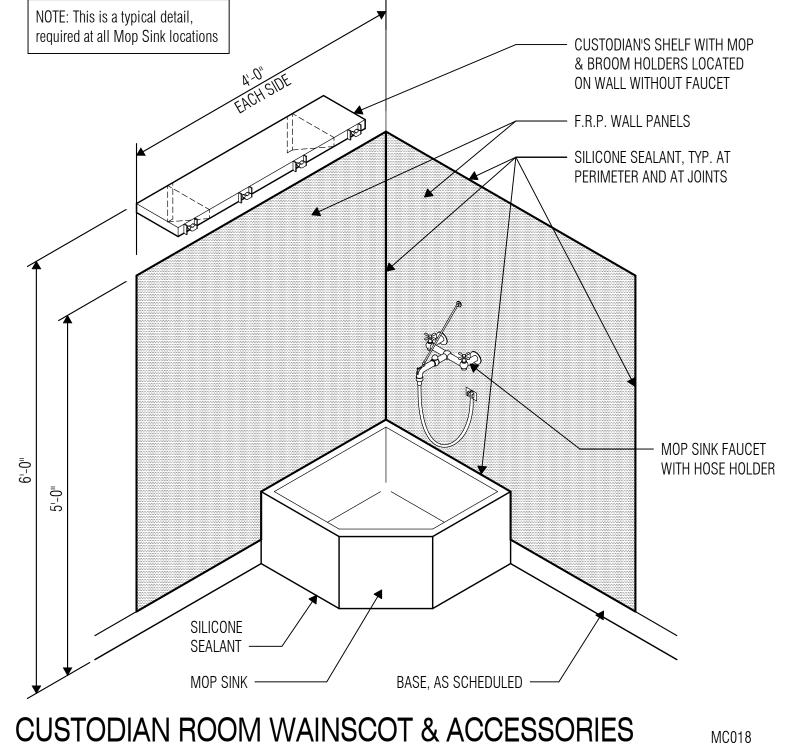



NOTES.
1. All items are contractor-furnished and installed unless noted otherwise.
2. Provide blocking in walls for all wall-mounted items, including L.F.C.I. and L.F.L.I. items.
3. All mounting heights are from finished flooring material at centerline of accessory.


- 4. Mounting height of mirrors at Standard Height Lavatories should be installed such that the bottom of mirror aligns with bottom of accessible mirror when possible.
- 6. At accessible toilet rooms and compartments (including at ambulatory-accessible toilet compartments) for child-only use at Pre-K facilities with 12" high water closets, install grab bars at 19 1/2" to top and install toilet tissue dispensers at 14" to outlet.
- BOT. = BOTTOM BOT.R.S. = BOTTOM OF REFLECTIVE SURFACE | CTRL. = CONTROLS= STANDARD5. Child Accessible Mounting Height shall be 40" when primary users are ages 6 through 8, and 36" when primary users are ages 3 | L.F.C.I. = LEASEE FURNISHED CONTRACTOR INSTALLED L.F.L.I. = LEASEE FURNISHED LEASEE INSTALLED


ACCESS. = ACCESSIBLE

PROJECT NO. 23-018.00


SHEET NO.

A2.41

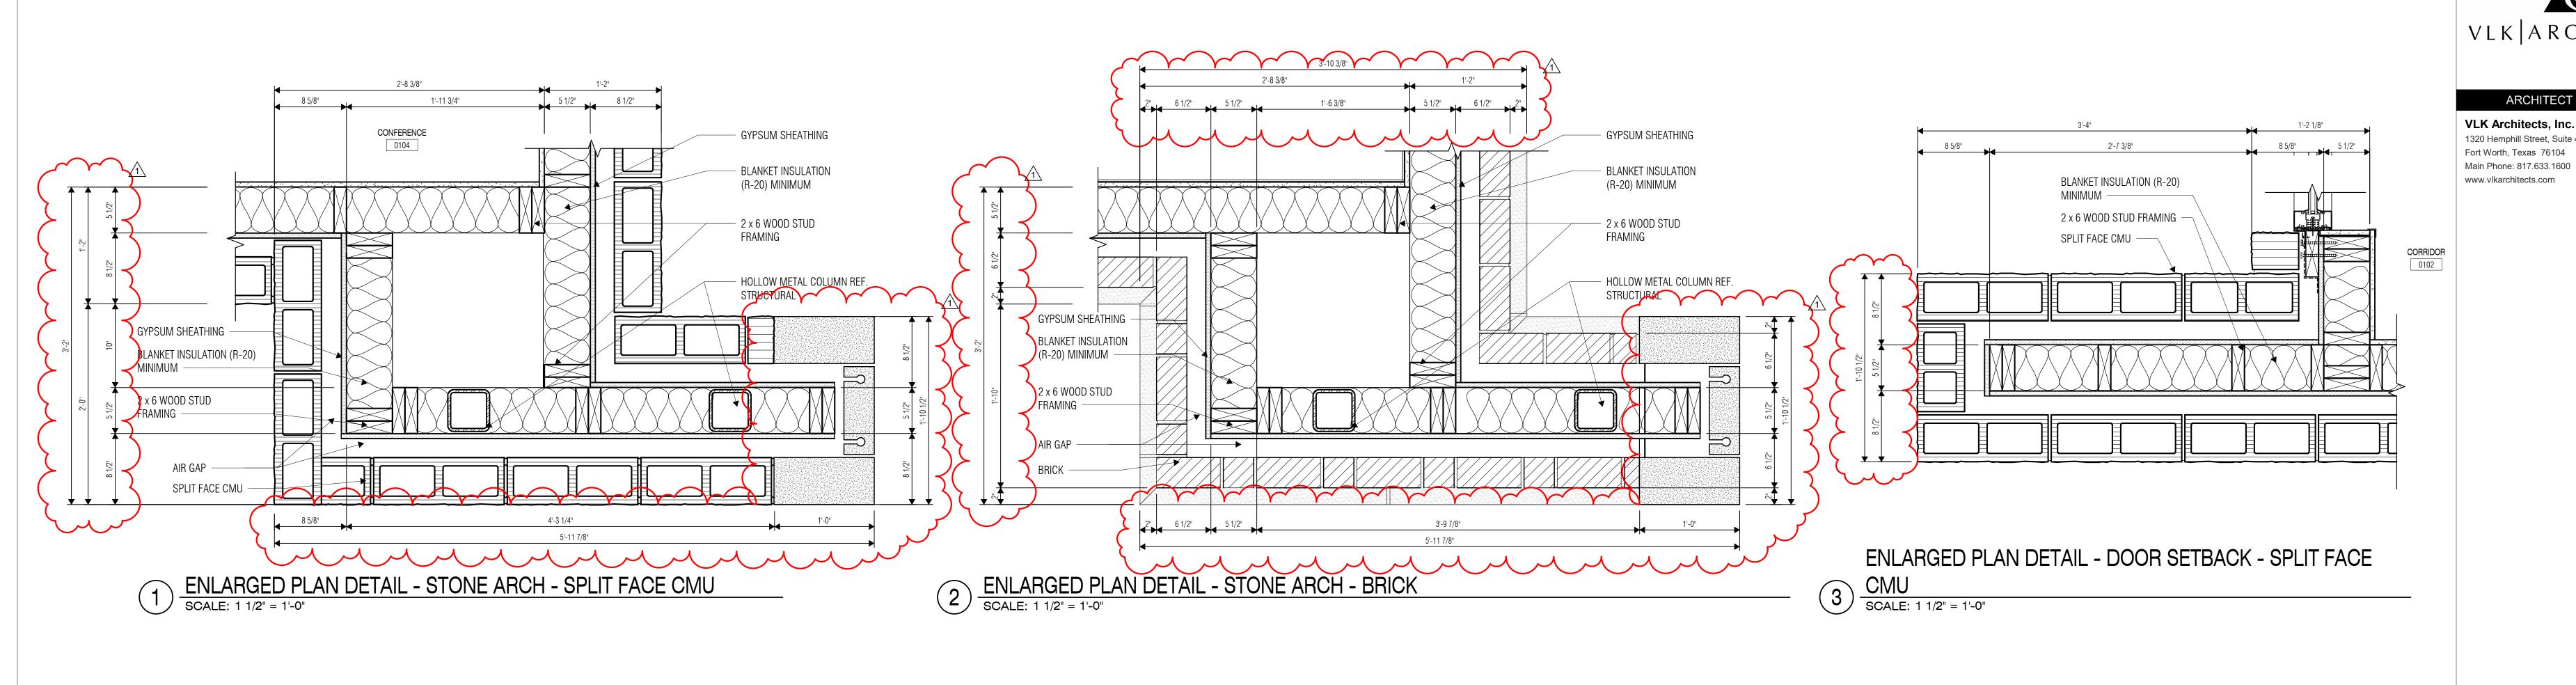


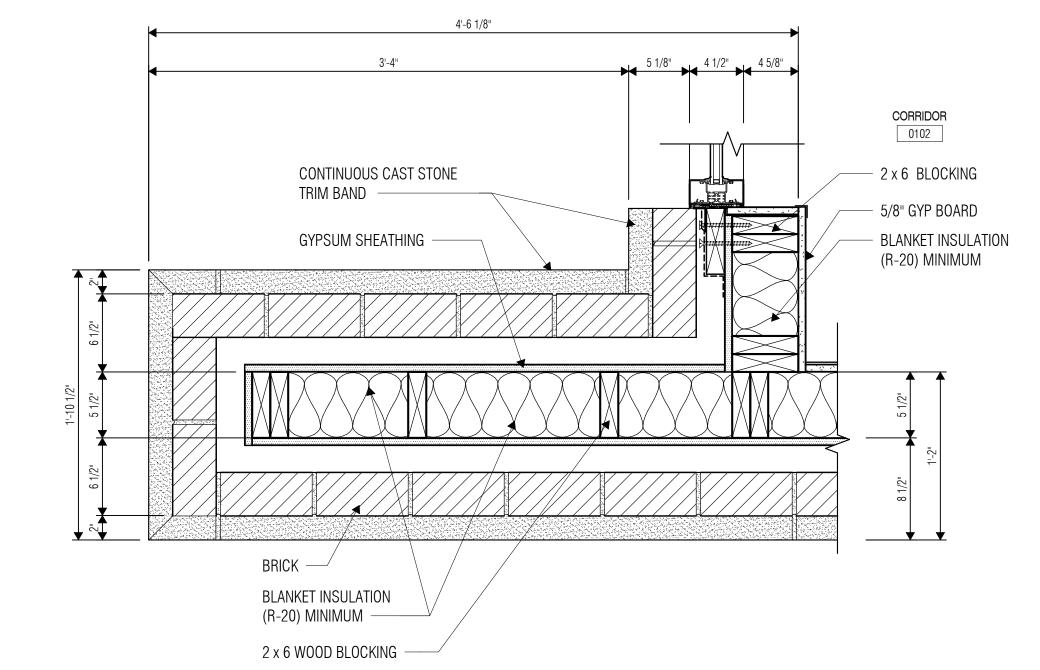


4 ENLARGED PLAN DETAIL - DOOR SETBACK - BRICK SCALE: 1 1/2" = 1'-0"

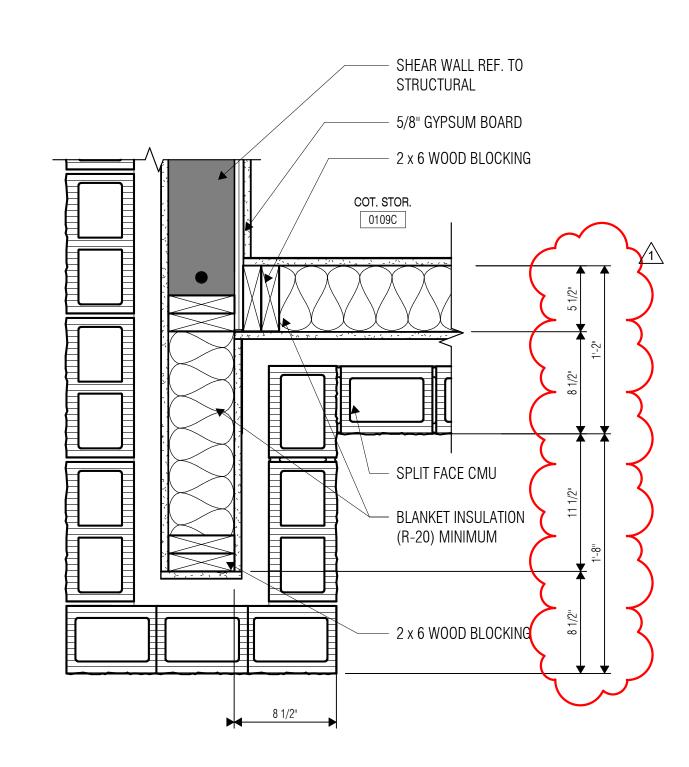


) PLAN DETAIL - GABLE WING WALL - SPLIT FACE CMU SCALE: 1 1/2" = 1'-0"

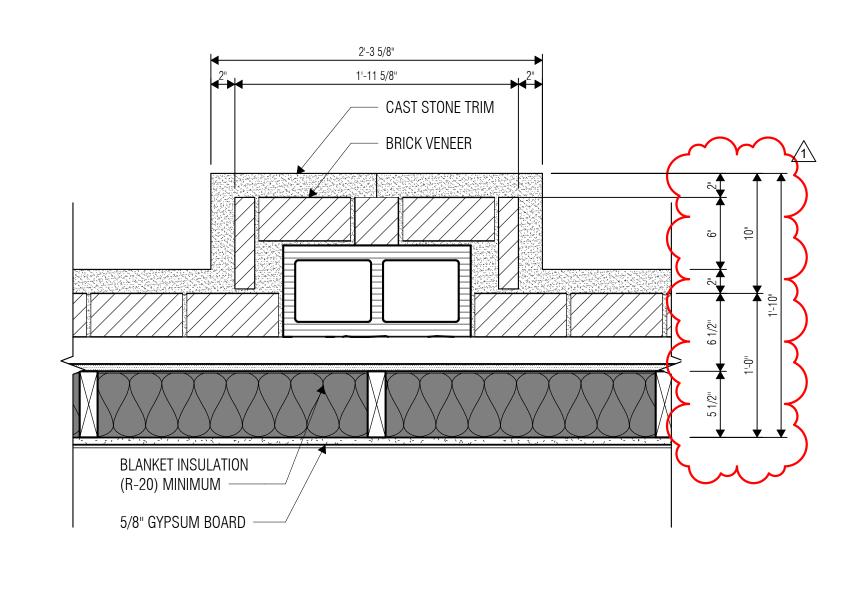


5 ENLARGED PLAN DETAIL - PILASTER - BRICK SCALE: 1 1/2" = 1'-0"

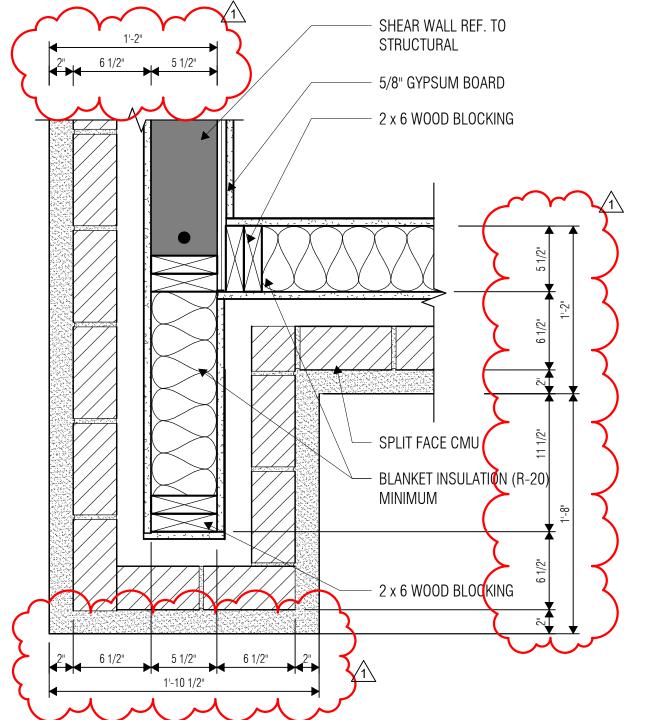

8 ENLARGED PLAN DETAIL - GABLE WING WALL - BRICK SCALE: 1 1/2" = 1'-0"

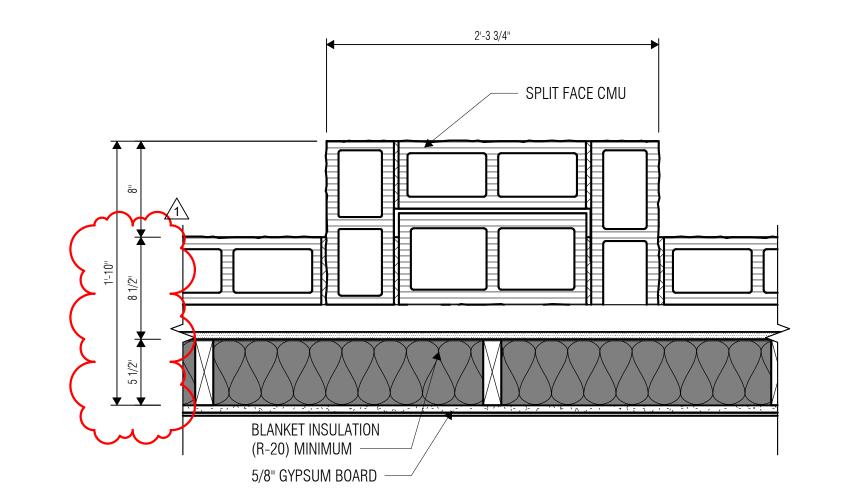

6 ENLARGED PLAN DETAIL - PILASTER - SPLIT FACE CMU SCALE: 1 1/2" = 1'-0"

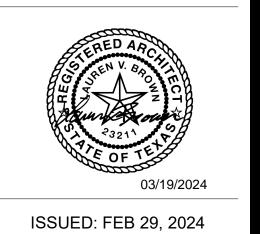

REVISIONS				
R	evision No.		Revision Date	
1	Addendum 01		03-19-2024	

Director Approver Designer **Quality Control** Designer Proj. Arch. Checker

SHEET TITLE

ENLARGED PLAN DETAILS

VLK Architects, Inc.

1320 Hemphill Street, Suite 400 Fort Worth, Texas 76104 Main Phone: 817.633.1600 www.vlkarchitects.com

EXTERIOR ELEVATION LEGEND

EXTERIOR ELEVATION NOTES

- B BRICK VENEER, TYPE 'B' AS SPECIFIED C BRICK VENEER, TYPE 'C' AS SPECIFIED D BRICK VENEER, TYPE 'D' AS SPECIFIED DS DOWNSPOUT
- DSC DOWNSPOUT W/ SCUPPER & CONDUCTOR HEAD REF. 2/A5.11 OS OVERFLOW SCUPPER, REF. 6/A5.11
- CJ CONTROL JOINT, REF. 3 & 5/A2.21
- (SXX) ALUMINUM STOREFRONT, REF. SHEET A7.11

Refer to Sheet A2.21 for Typical Control Joint and Building Expansion Joint Based on the applicable design criteria, submit the proposed pattern of control joints in masonry veneer, CMU and stucco/cement plaster to the Architect for review and approval prior to construction. Verify mounting heights of all Electrical and Mechanical items on the exterior of the building prior to construction, whether specifically indicated on the Exterior Elevations or not. Install cast stone in accordance with the recommendations of the Cast Stone Institute, unless specifically noted or detailed otherwise. Refer to Sheet A3.11 for Loose Lintel Details. Refer to Structural Drawings for maximum span and bearing requirements. Terminate recessed and projected masonry veneer courses at 4" from intersecting window frames, door frames, sloping roofs, etc., unless noted Provide solid bricks for soldier courses at exterior corners (do not miter). Refer to Detail 2/A3.11. A BRICK VENEER. TYPE 'A' AS SPECIFIED

- PREFINISHED SHEET

— ASPHALT SHINGLES

— PREFINISHED SHEET

— GFRC FASCIA CORNICE

METAL GUTTER

— FACE BRICK 'B'

METAL GUTTER

- FACE BRICK 'A' ——

- CONTINUOUS CAST STONE TRIM

BAND; PIECES 4'-0" LONG MAX

PRE-FABRICATED, PREFINISHED ASPHALT SHINGLES — 1/2" RECESSED BRICK GABLE PANEL, OPERATING LOUVERED DORMER 1/2" RECESSED BRICK GABLE PANEL, BRICK TYPE 'D' - DARK IRON SPOT BRICK TYPE 'D' - DARK IRON SPOT -PREFINISHED SHEET METAL GUTTER —— PREFINISHED SHEET METAL COPING - PREFINISHED SHEET METAL UPPER PLATE HT. 116'-6" UPPER PLATE HT. COPING PLATE HT. 114'-0" PLATE HT. 114'-0" GFRC FASCIA CORNICE FACE BRICK 'B' -FACE BRICK 'A' - PREMANUFACTURED FACE BRICK 'A' SPLIT-FACE CMU SPLIT-FACE CMU — CONTINUOUS CAST STONE TRIM BAND; PIECES 4'-0" LONG MAX CONTINUOUS CAST STONE TRIM BAND; PIECES 4'-0" LONG MAX FACE BRICK 'A' 2 BUILDING ELEVATION - SOUTH
SCALE: 1/8" = 1'-0"

- PRE-FABRICATED, PREFINISHED OPERATING

LOUVERED DORMERS. ALIGN CENTERED ON

WINDOWS BELOW AS SHOWN -

- LUGGED CAST STONE

ALUMINUM STOREFRONT

A3.12

CONTINUOUS CAST

STONE TRIM BAND;

PIECES 4'-0" LONG MAX -

CAST STONE TRIM


ASPHALT SHINGLES


ROWLOCK FRAME WITH BASKET WEAVE PATTERN, REF. 1/A3.12


FACE BRICK 'B' FACE BRICK 'A'

4 BUILDING ELEVATION - NORTH SCALE: 1/8" = 1'-0"

FACE BRICK 'A' ——

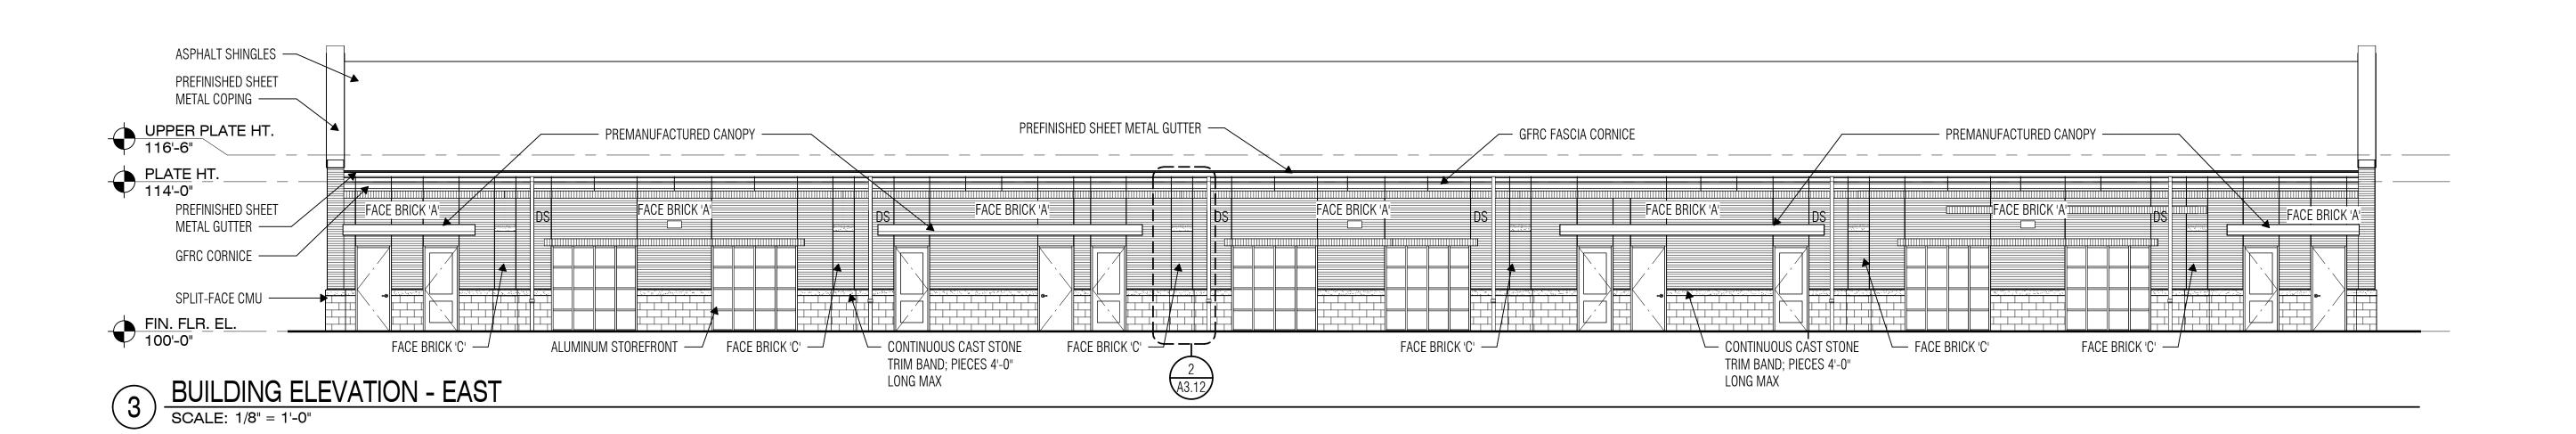

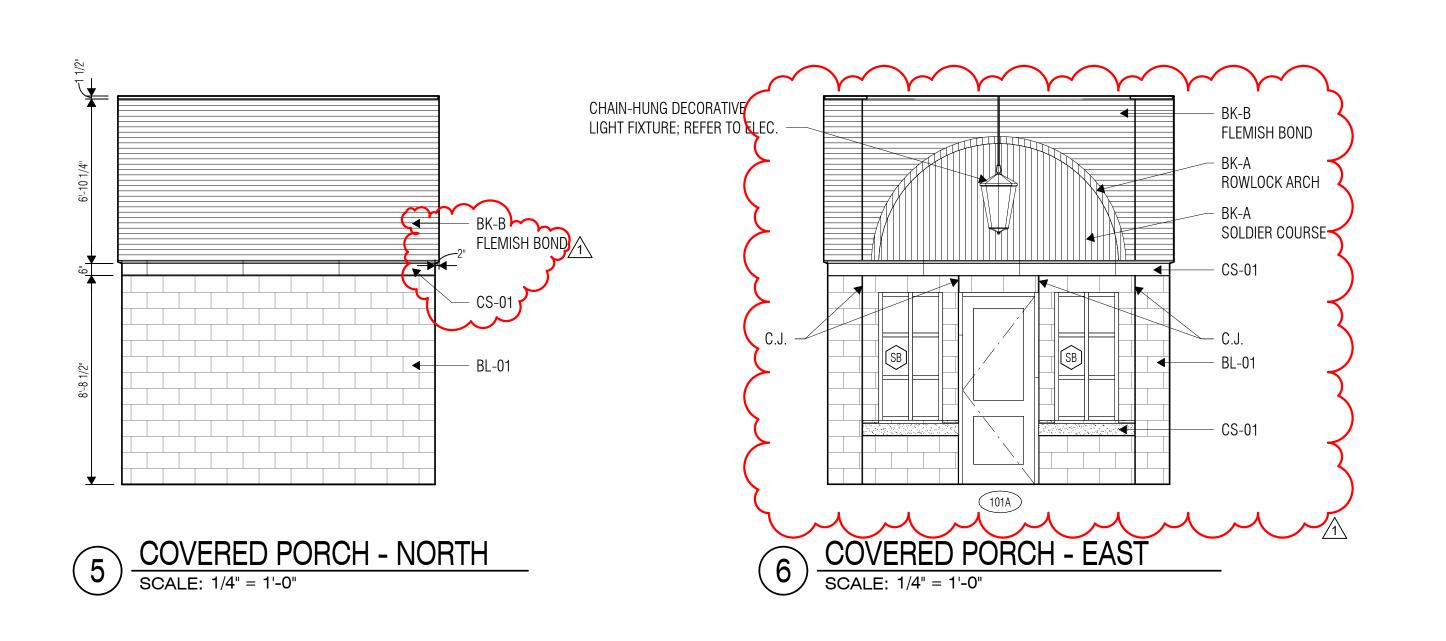

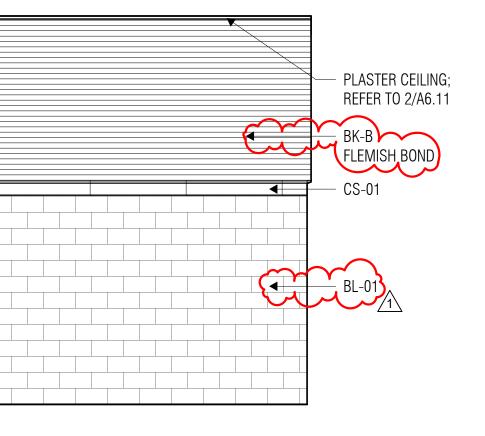

—— PRE-FABRICATED, PREFINISHED OPERATING

WINDOWS BELOW AS SHOWN -

LOUVERED DORMERS. ALIGN CENTERED ON

- LUGGED CAST STONE


- PRE-FABRICATED, PREFINISHED

OPERATING LOUVERED DORMER

FACE BRICK 'A'


COVERED PORCH - SOUTH

SCALE: 1/4" = 1'-0"

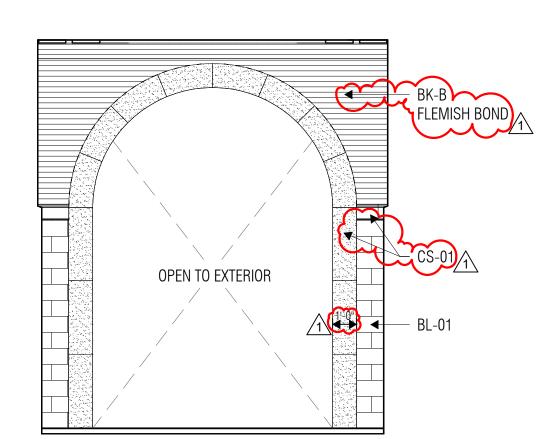

COVERED PORCH - WEST

SCALE: 1/4" = 1'-0"

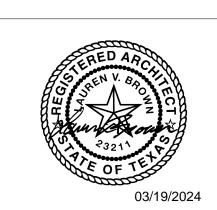

P, DE

ISSUED: FEB 29, 2024

REVISIONS Revision Date 03-19-2024 1 Addendum 01

Director Drawn By Approver Author Designer **Quality Control** Designer Proj. Arch.

Checker PROJECT NO.

23-018.00

SHEET TITLE

EXTERIOR ELEVATIONS

SHEET NO.

A3.01



- CONTINUOUS CAST STONE FACE BRICK 'A' -TRIM BAND; PIECES 4'-0"

BUILDING ELEVATION - WEST SCALE: 1/8" = 1'-0"

ASPHALT SHINGLES —

PREFINISHED SHEET

METAL COPING ——

UPPER PLATE HT. 116'-6"

PREFINISHED SHEET

GFRC FASCIA CORNICE —

MEAL GUTTER -

FACE BRICK 'A' -

SPLIT-FACE CMU —

PLATE HT. 114'-0"

Drawn By Director Author Quality Control

Approver Designer Designer Proj. Arch. Checker

PROJECT NO.

23-018.00


SHEET TITLE

EXTERIOR ELEVATION DETAILS

SHEET NO.


A3.12




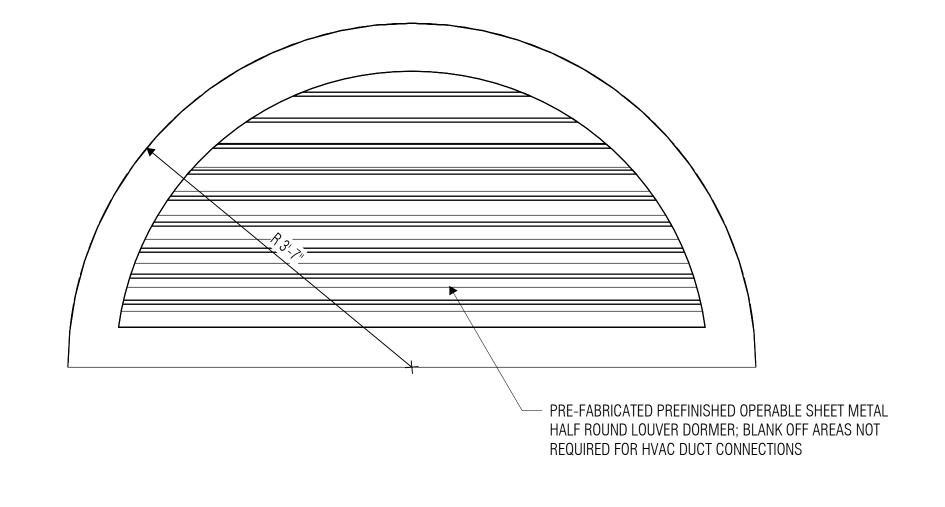


BUILDING ELEVATION DETAIL - LOUVERED DORMER

SCALE: 1" = 1'-0"

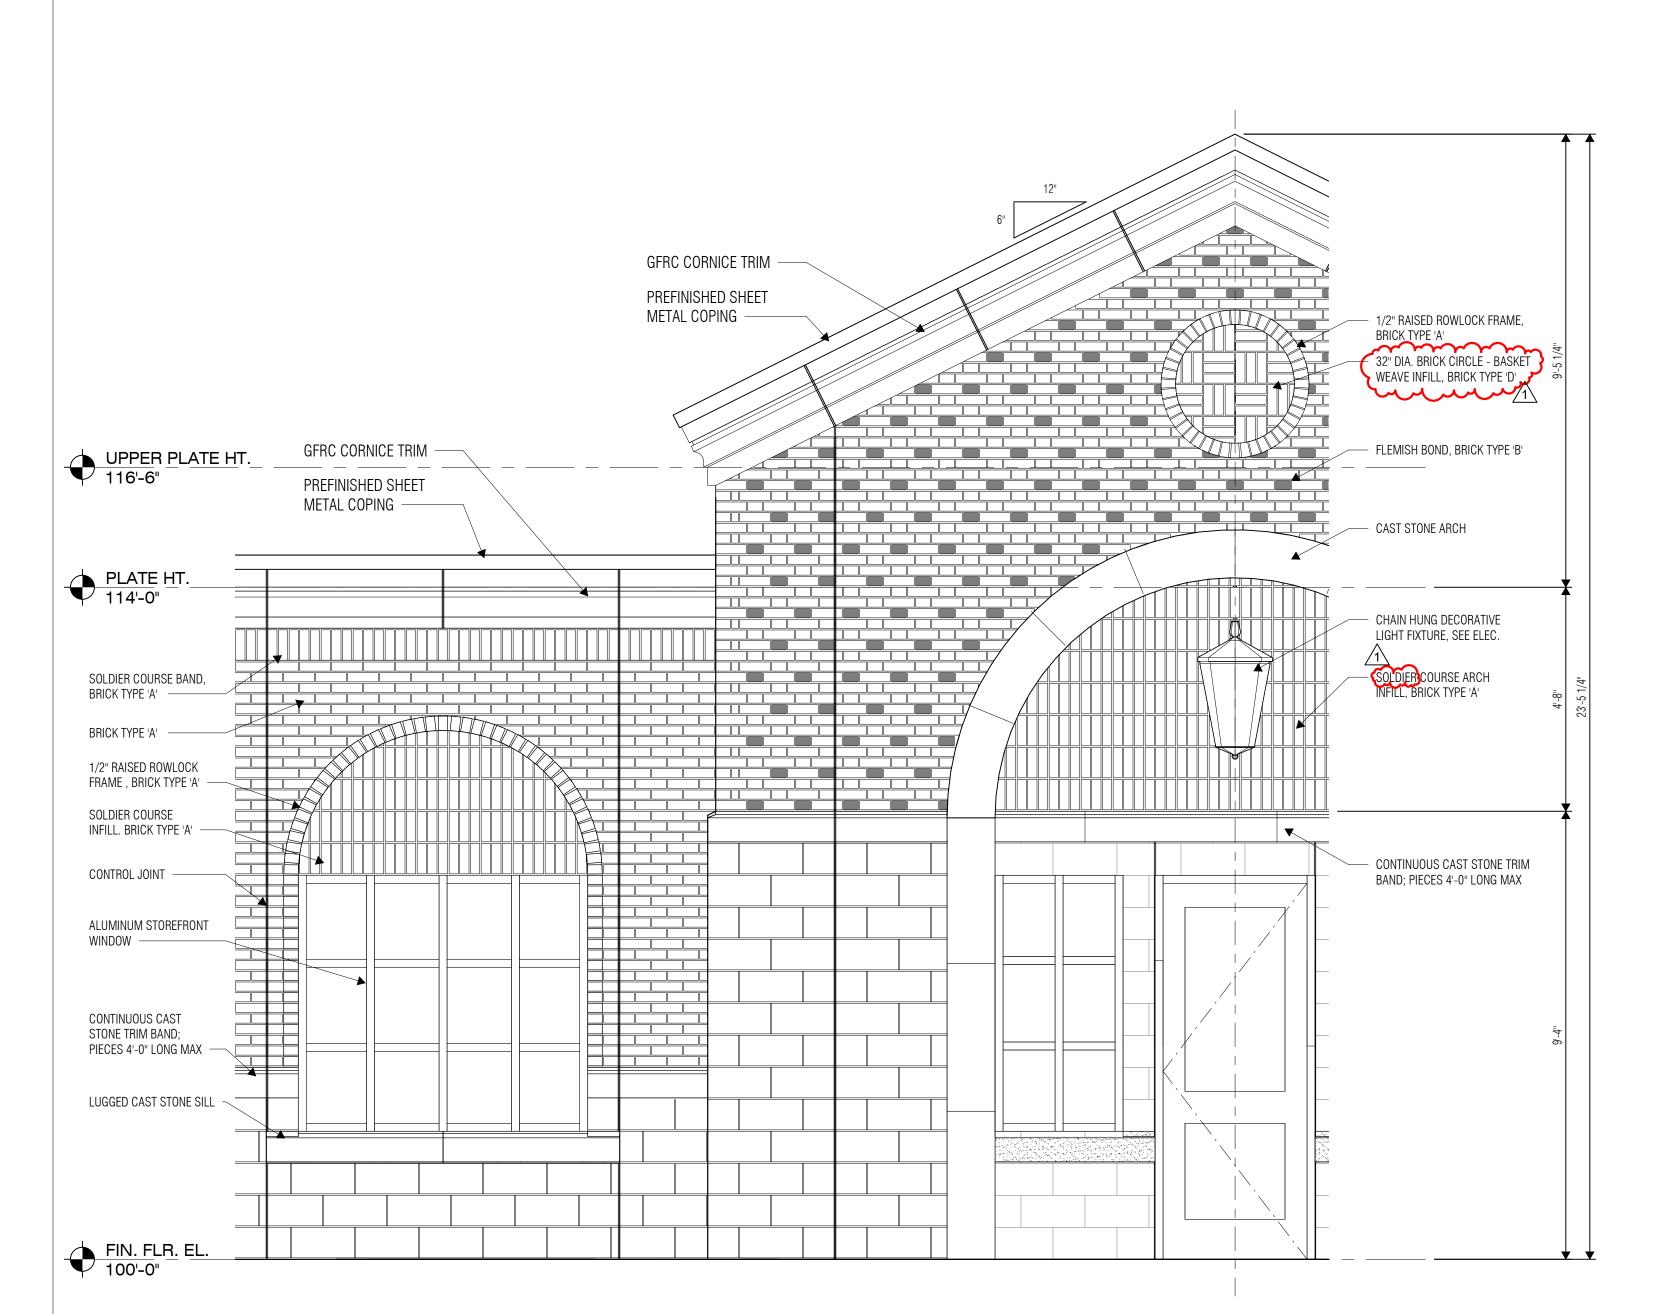

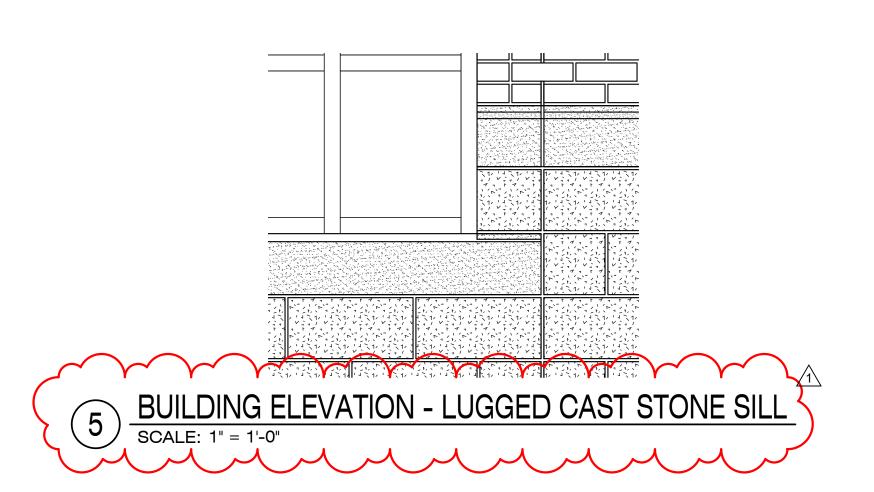

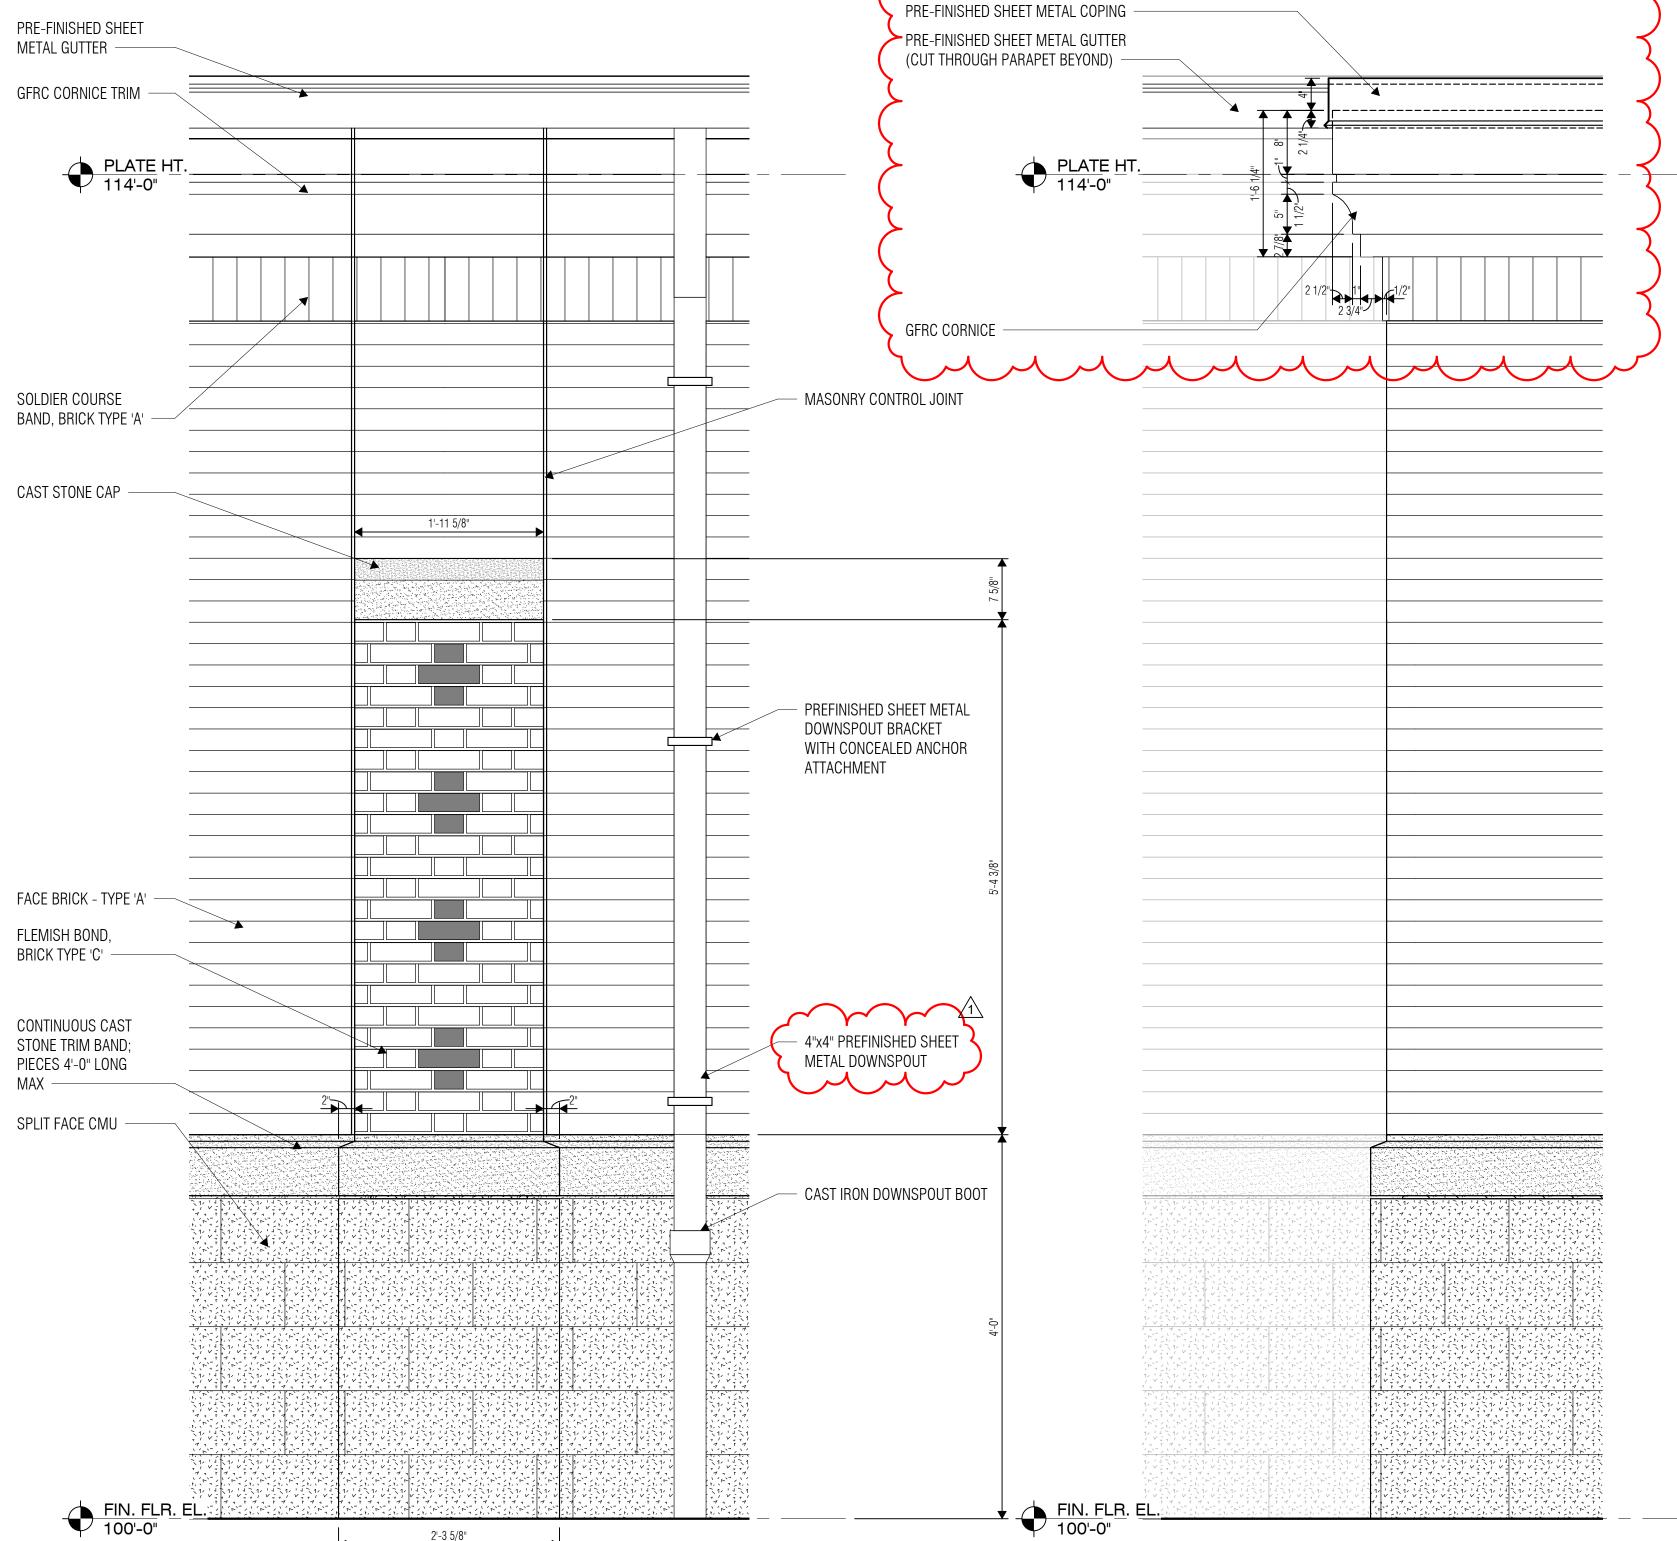


) BUILDING ELEVATION DETAIL - PILASTER SCALE: 1" = 1'-0"

2'-3 5/8"

BUILDING ELEVATION - WEST - Callout 4

) BUILDING ELEVATION DETAIL - ENTRANCE PORCH SCALE: 1/2" = 1'-0"

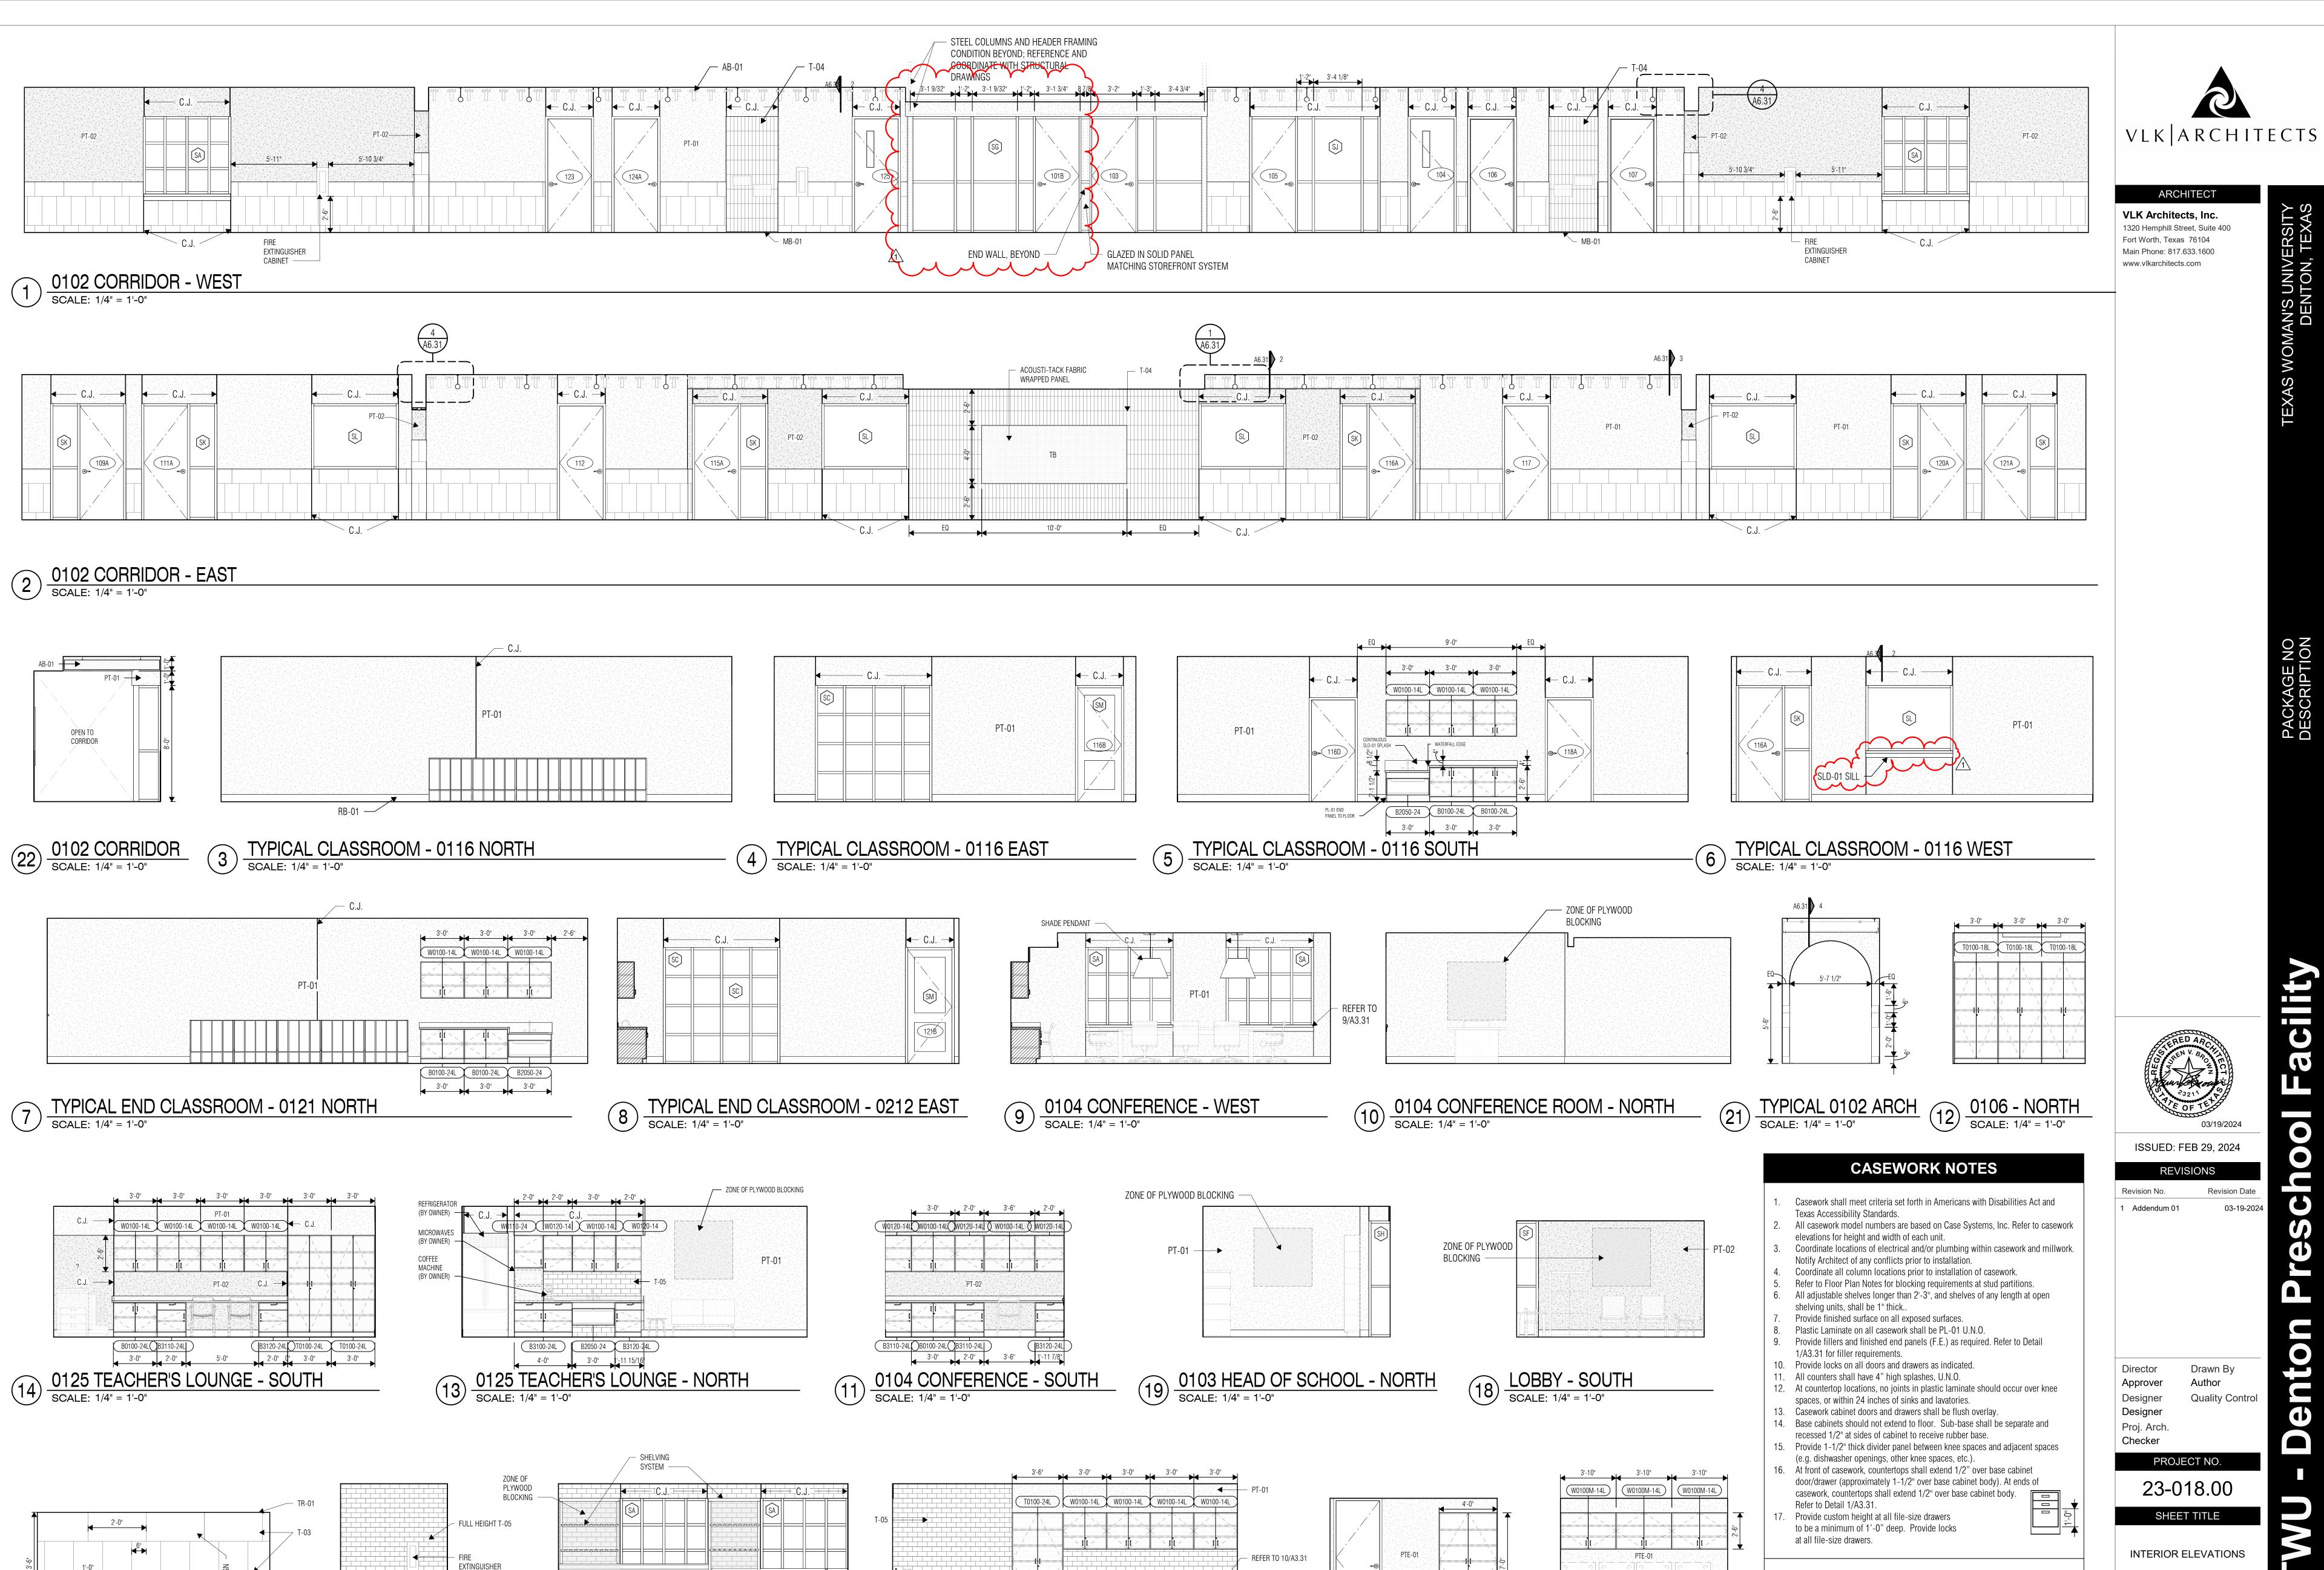

MB-01 -

16 0124 KITCHEN - NORTH
SCALE: 1/4" = 1'-0"

HAND SINK —

ROLLING CARTS

(BY OWNER)

FRP UNDER

COUNTER

CABINET

MB-01

(20) TYPICAL WAINSCOT PATTERN (15) TYPICAL 0124 WALL (17) 0124 KITCHEN - WEST SCALE: 1/2" = 1'-0" (17) SCALE: 1/4" = 1'-0"

MB-01

P,

ISSUED: FEB 29, 2024

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1 Addendum 01

Drawn By Author

Quality Control

PROJECT NO.

23-018.00

SHEET NO.

CASEWORK NOMINAL DEPTH

V = LIGHT VALANCE PANEL

(C.S.I. #R9600-03)

M = MODIFIED FROM L = LOCKED CABINET

1. The height indicated at base cabinets includes the countertop.

C.S.I. CATALOG

0123 LAUNDRY - WEST
SCALE: 1/4" = 1'-0"


T0100-14L

23 0123 LAUNDRY - EAST SCALE: 1/4" = 1'-0"

CASEWORK NUMBER ———

STANDARD CATALOG SELECTION

A3.21

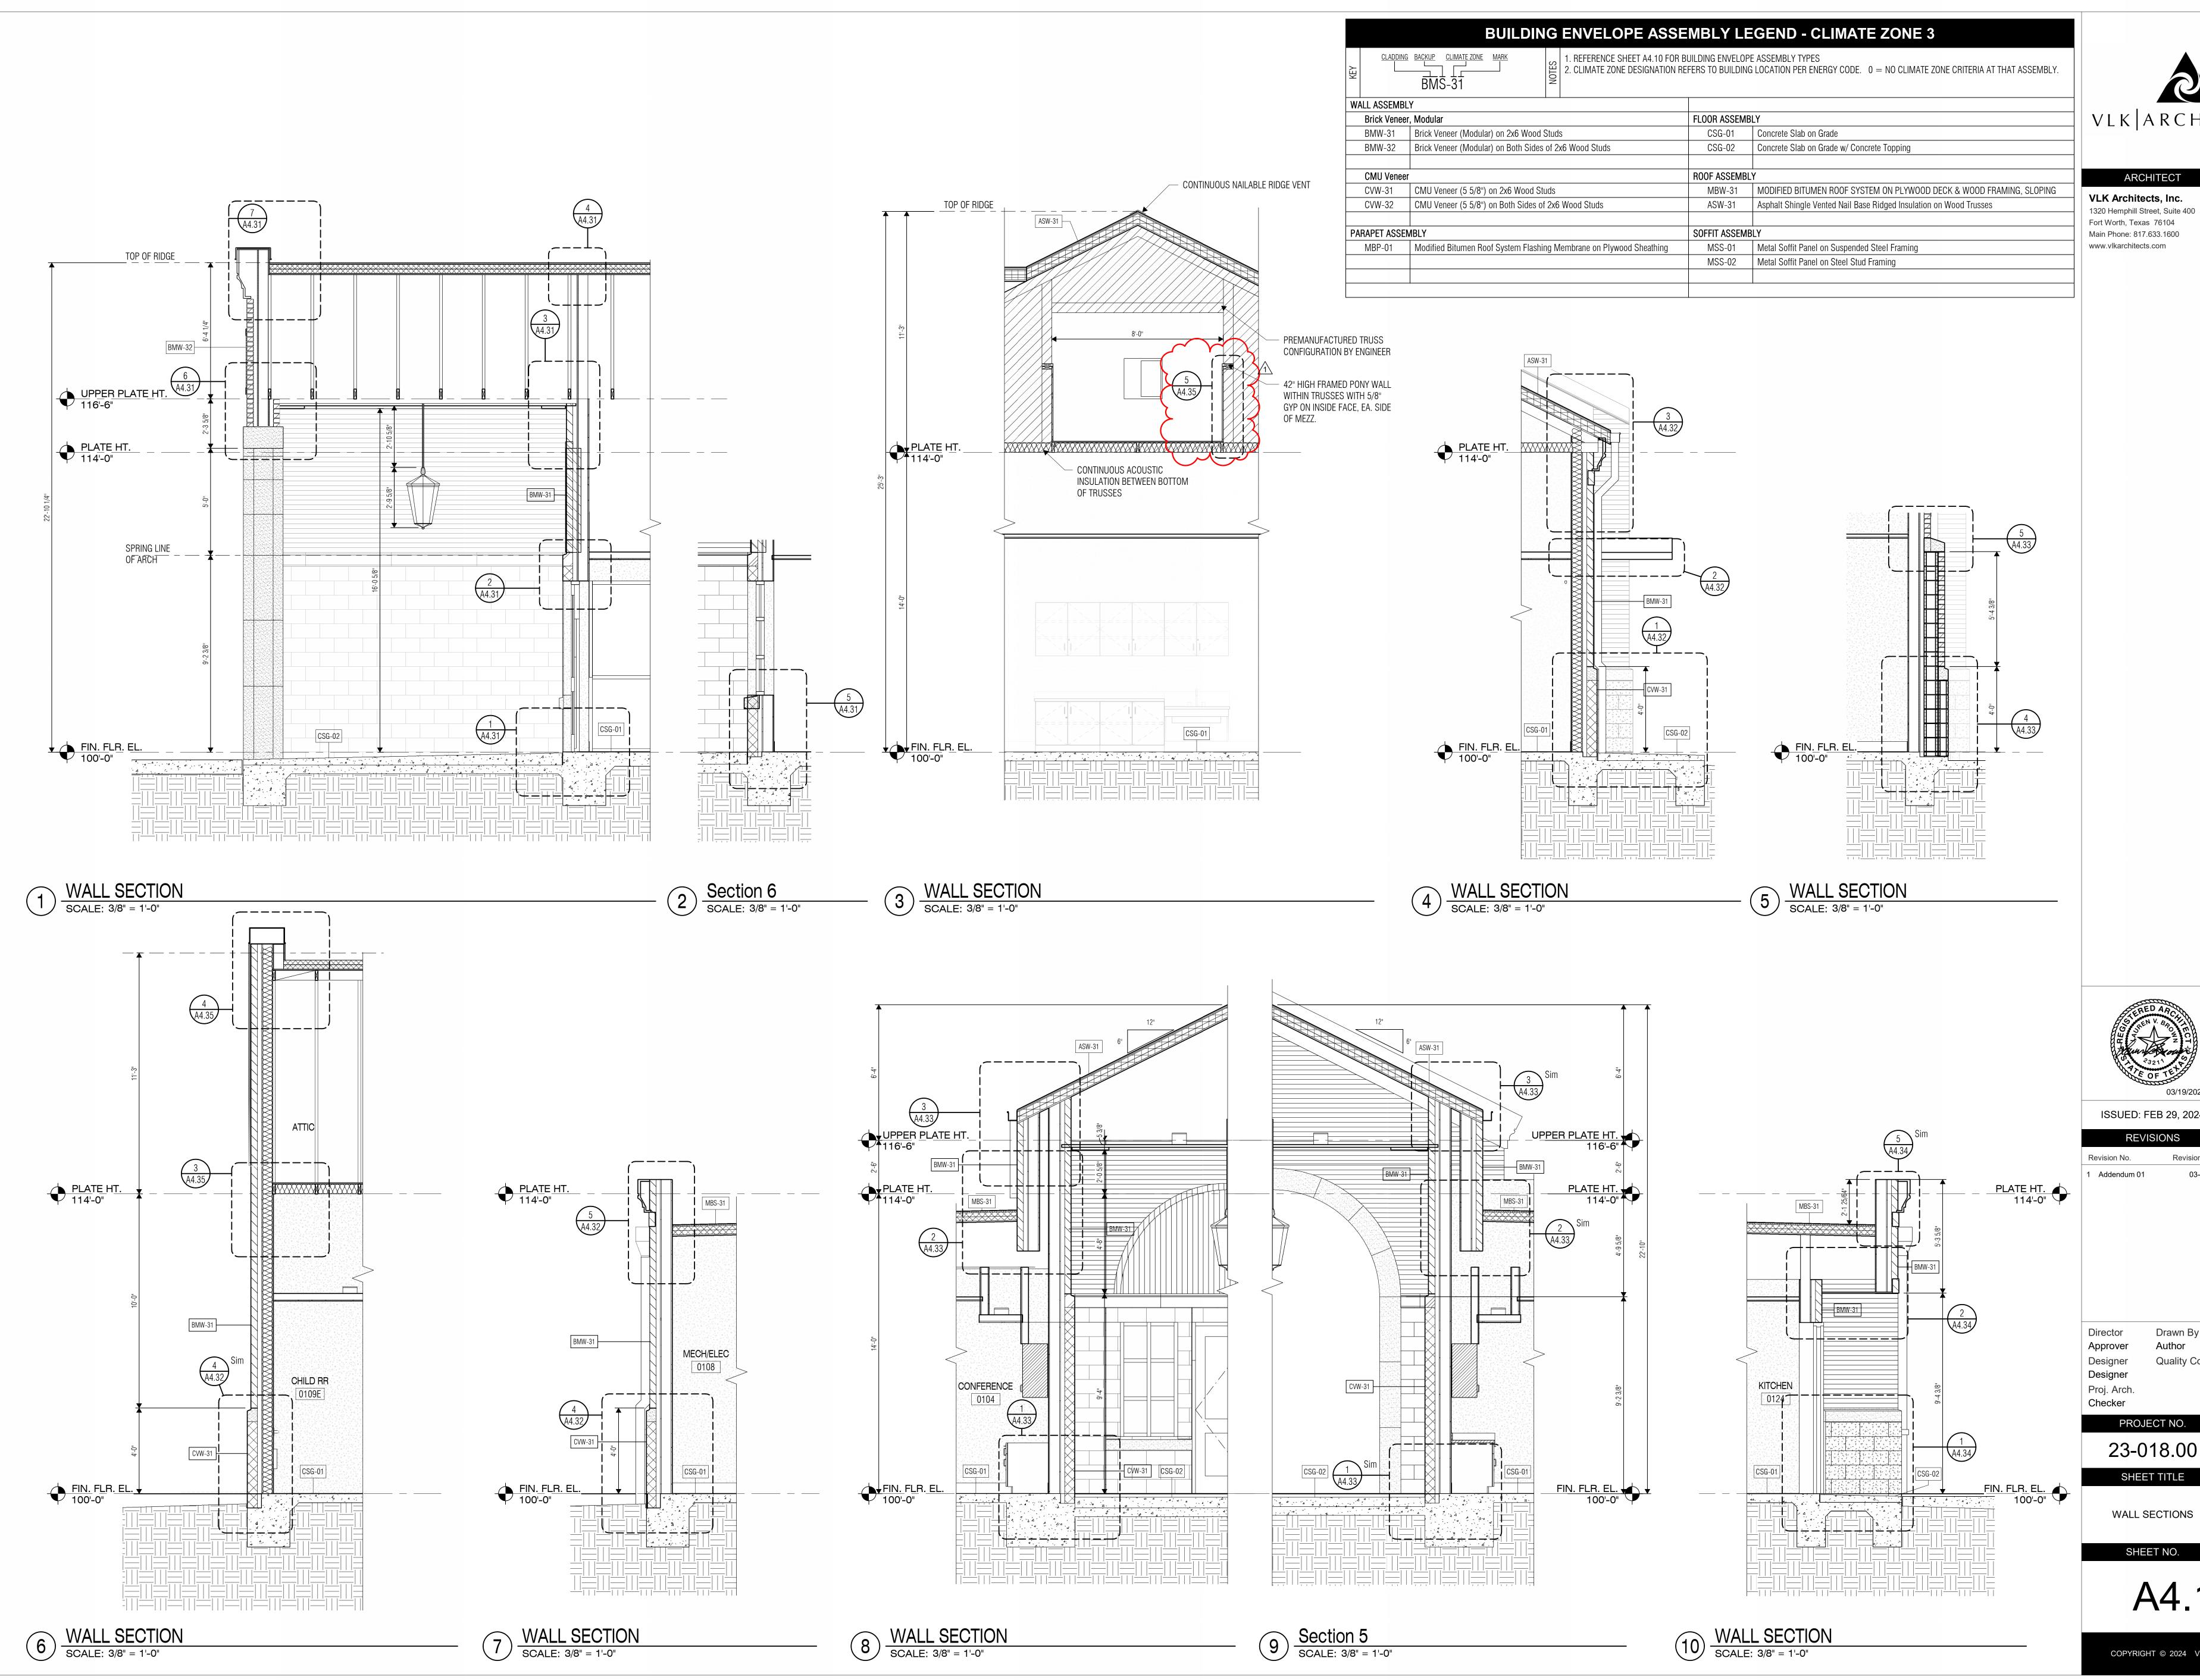

VLK ARCHITECTS

ARCHITECT

VLK Architects, Inc. 1320 Hemphill Street, Suite 400 Main Phone: 817.633.1600

ISSUED: FEB 29, 2024

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Quality Control

PROJECT NO. 23-018.00

SHEET NO.

A4.11

P,

Revision Date

REVISIONS

Revision No.

Checker

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> PROJECT NO. 23-018.00


SHEET TITLE

BUILDING ASSEMBLY

DETAILS SHEET NO.

A4.31




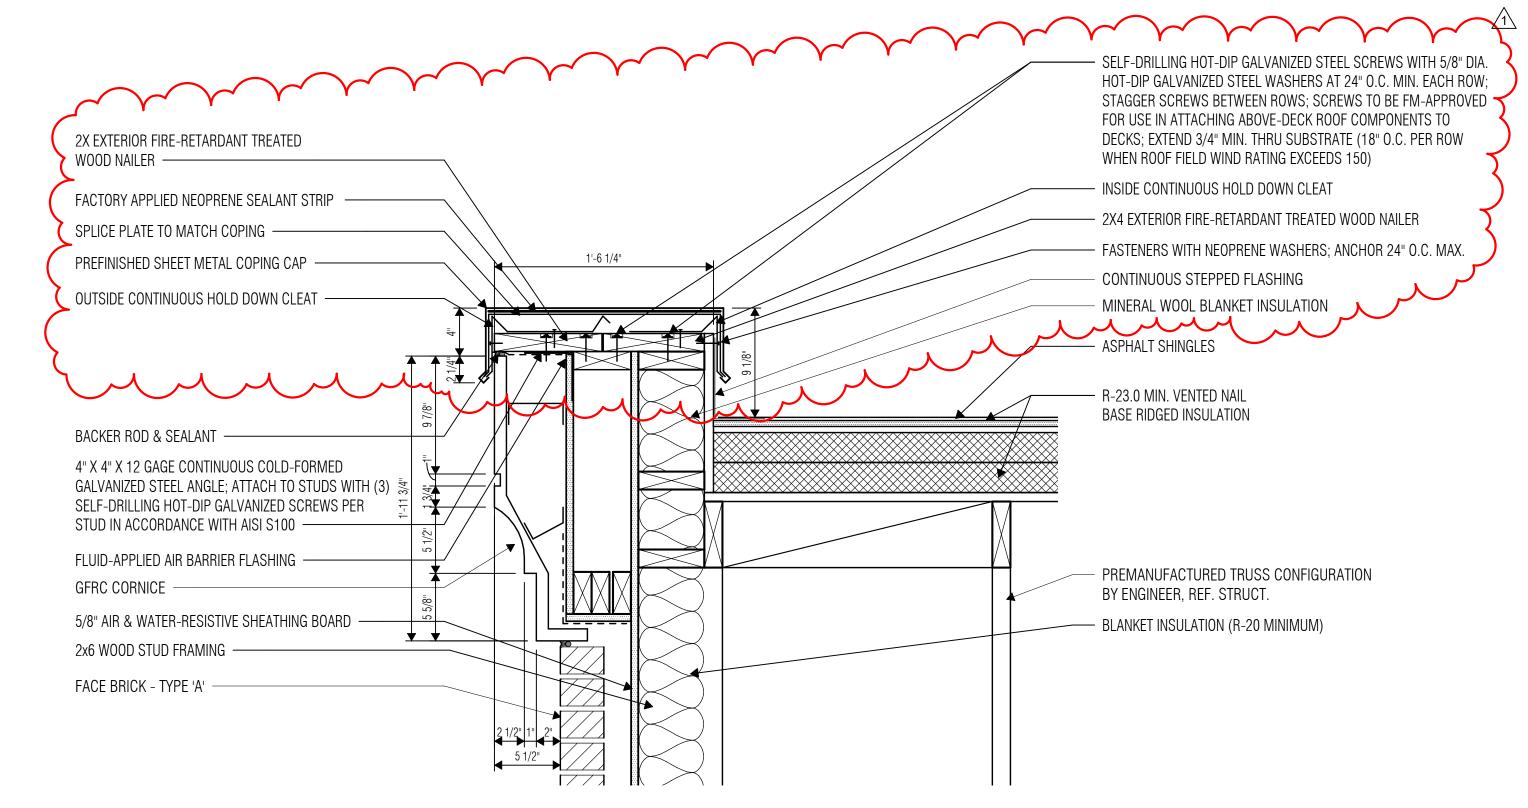


WALL SECTION - ENTRY - ROOF 1 SCALE: 1 1/2" = 1'-0"

> BLANKET INSULATION (R-20 MINIMUM) EXTERIOR 2x6 STUD FRAMING 5/8" AIR & WATER-RESISTIVE SHEATHING BOARD -32" DIA. BASKET WEAVE BRICK CIRCLE - PREMANUFACTURED TRUSS 1/2" RAISED ROW LOCK FRAME - BRICK TYPE 'A' CONFIGURATION BY ENGINEER, REF. STRUCT. FACE BRICK - TYPE 'A' — UPPER PLATE HT. 10" HIGH CAVITY DRAINAGE MATERIAL. FULL DEPTH OF CAVITY, WITH INSECT BARRIER FABRIC TOWARDS BRICK — - HUNG COLD FORMED CHANNEL FRAMING SELF-ADHERING FLEXIBLE THROUGH-WALL FLASHING MEMBRANE - CEMENT PLASTER ON METAL LATH CELLULAR PLASTIC WEEPS AT 24" O.C. —— - 1 1/2" CONT. VENT - 12"x6" HSS, REF. STRUCT. 4" CHANNEL HANGERS, REF. - 6" x 6" STEEL ANGLE, REF. STRUCT. 5 5/8" 3/8" 10 1/2" 3/8" 5 5/8"

WALL SECTION - ENTRY - STONE ARCH SCALE: 1 1/2" = 1'-0"

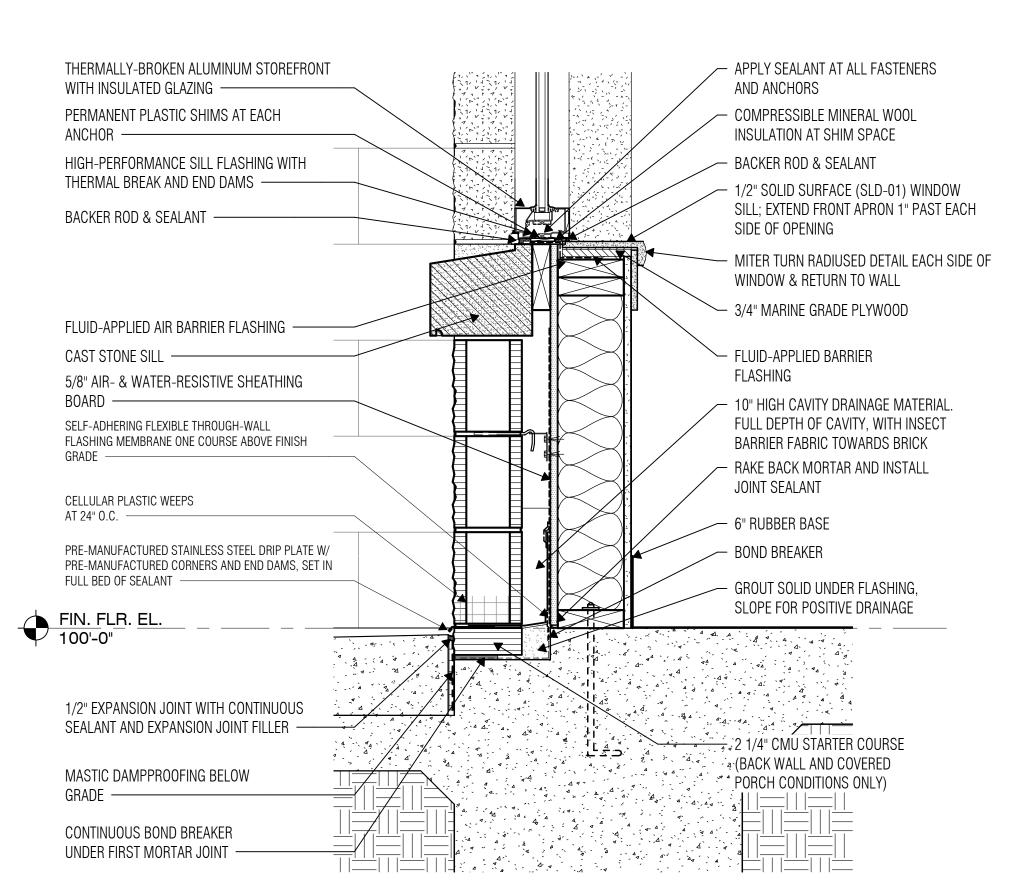

SCALE: 1 1/2" = 1'-0"

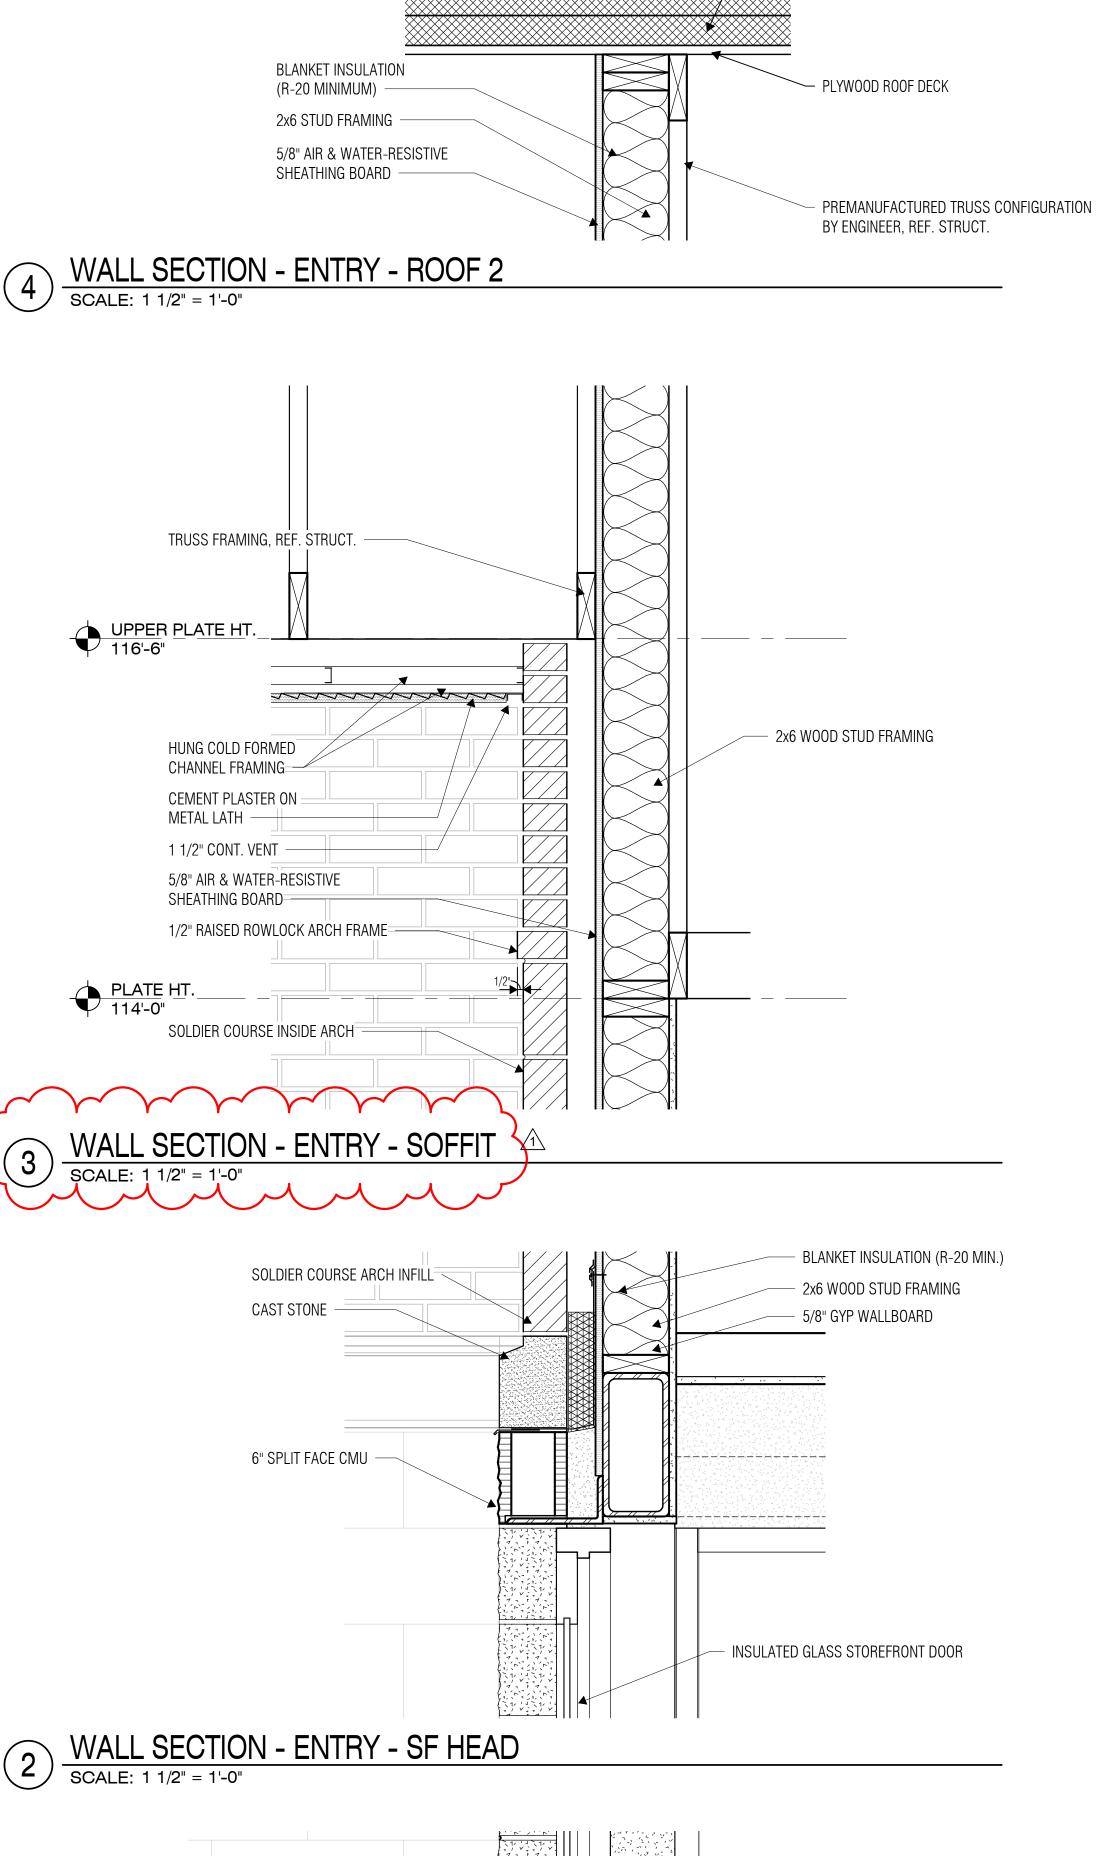


ASPHALT SHINGLES

---- R-23.0 MIN. VENTED NAIL

BASE RIDGED INSULATION

2 WALL SECTION - ENTRY - SF HEAD SCALE: 1 1/2" = 1'-0"

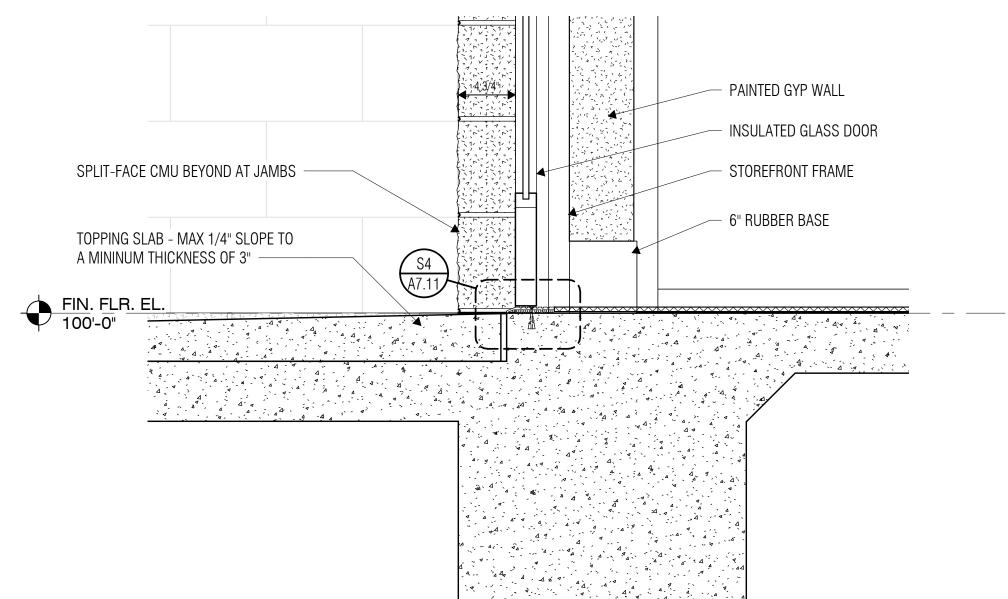

WALL SECTION - ENTRY - BASE

SCALE: 1 1/2" = 1'-0"

03-19-2024

Drawn By

Director Author Approver Designer Quality Control Designer Proj. Arch. Checker

> PROJECT NO. 23-018.00

SHEET TITLE

BUILDING ASSEMBLY DETAILS

SHEET NO.

A4.32

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5 WALL SECTION - MECH/ELEC - ROOF

SCALE: 1 1/2" = 1'-0" FACE BRICK - TYPE 'A' -CAST STONE -5/8" AIR & WATER-RESISTIVE SHEATHING BOARD -6" SPLIT FACE CMU -5"x5" PREFINISHED SHEETMETAL DOWNSPOUT WITH CAST IRON BOOT. TIED INTO STORM LINE, REF. CIVIL. SELF-ADHERING FLEXIBLE THROUGH-WALL 2x6 EXTERIOR STUD WALL FRAMING FLASHING MEMBRANE ONE COURSE ABOVE FINISH GRADE -- 5/8" GYPSUM BOARD CELLULAR PLASTIC WEEPS AT 24" O.C. - 6" RUBBER BASE PRE-MANUFACTURED STAINLESS STEEL DRIP PLATE W/ PRE-MANUFACTURED CORNERS AND END DAMS, SET IN FULL BED OF SEALANT — FIN. FLR. EL. 100'-0" BOND BREAKER ≟⊤RAKÉ BACK MORTAR AND INSTALL JOINT GROUT SOLID UNDER FLASHING, SLOPE FOR POSITIVE DRAINAGE CONTINUOUS BOND BREAKER UNDER FIRST MORTAR JOINT

WALL SECTION - MECH/ELEC - BASE

SCALE: 1 1/2" = 1'-0"

2X EXTERIOR FIRE-RETARDANT TREATED

SPLICE PLATE TO MATCH COPING ——

PREFINISHED SHEET METAL COPING CAP —

OUTSIDE CONTINUOUS HOLD DOWN CLEAT -

4" X 4" X 12 GAUGE CONTINUOUS COLD-FORMED

STUD IN ACCORDANCE WITH AISI S100 -

FLUID-APPLIED AIR BARRIER FLASHING -

SCUPPER IN LINE WITH SOLDIER

PREFINISHED SHEET METAL

BRICK VENEER (MODULAR) —

2x6 WOOD STUD FRAMING —

5/8" AIR & WATER-RESISTIVE SHEATHING

BLANKET INSULATION (R-20 MINIMUM) —

PREFINISHED SHEET METL DOWNSPOUT BRACKET WITH CONCEALED ANCHOR ATTACHMENT —

LEADER HEAD AND 5"x5"

SELF-DRILLING HOT-DIP GALVANIZED SCREWS PER

GALVANIZED STEEL ANGLE; ATTACH TO STUDS WITH (3)

FACTORY APPLIED NEOPRENE SEALANT STRIP —

1'-7 5/8"

2 1/2" 1" 2 3/4

WOOD NAILER ———

BACKER ROD & SEALANT -

GFRC CORNICE

COURSE —

DOWNSPOUT -

PLATE HT. 114'-0"

SELF-DRILLING HOT-DIP GALVANIZED STEEL SCREWS WITH 5/8" DIA HOT-DIP GALVANIZED STEEL WASHERS AT 24" O.C. MIN. EACH ROW;

STAGGER SCREWS BETWEEN ROWS; SCREWS TO BE FM-APPROVED

FOR USE IN ATTACHING ABOVE-DECK ROOF COMPONENTS TO

— FASTENERS WITH NEOPRENE WASHERS; ANCHOR 24" O.C. MAX.

WHEN ROOF FIELD WIND RATING EXCEEDS 150)

—— 2X4 EXTERIOR FIRE-RETARDANT TREATED WOOD NAILER

INSIDE CONTINUOUS HOLD DOWN CLEAT

MINERAL WOOL BLANKET INSULATION

ROOF MEMBRANE FLASHING

PLYWOOD PARAPET SHEATHING

- 3/4" DENSDECK INSULATION COVER

- 2 LAYERS OF 2.3" THICK POLYISO

ROOF INSULATION w/ STAGGERED

- FIRE RETARDANT TREATED

MODIFIED BITUMEN ROOF

BOARD (R-2.0)

JOINTS (R-23.0)


PLYWOOD ROOF DECK

- PREMANUFACTURED


BY ENGINEER


TRUSS CONFIGURATION

DECKS; EXTEND 3/4" MIN. THRU SUBSTRATE (18" O.C. PER ROW

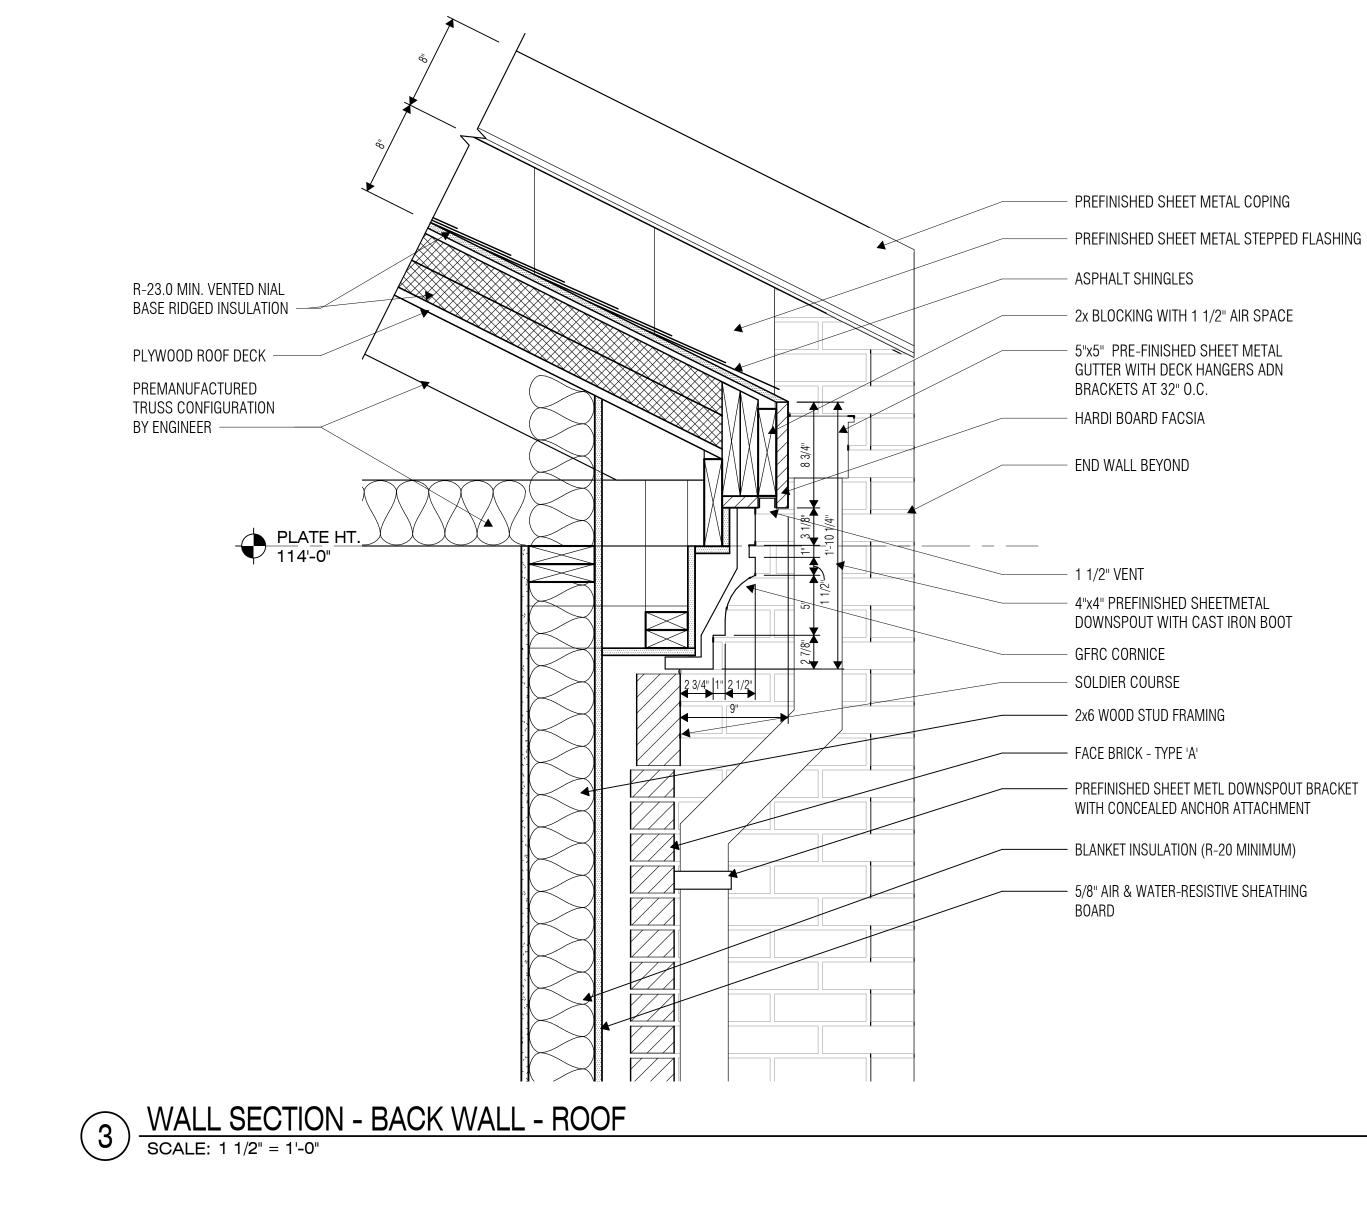

- FACE BRICK, TYPE 'A' 5x5 HSS COLUMN, REF. STRUCT. HSS STUB WITH METAL PLATE, REF. STRUCT. PREMANUFACURED MEAL CANOPY 2x6 WOOD STUD FRAMING BLANKET INSULATION (R-20 MIN.) - SOLDIER COURSE

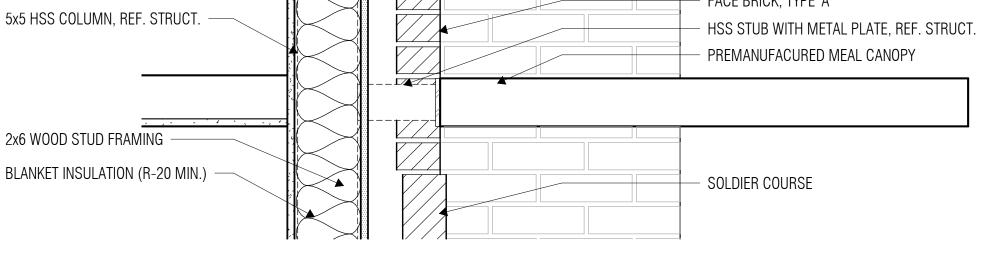

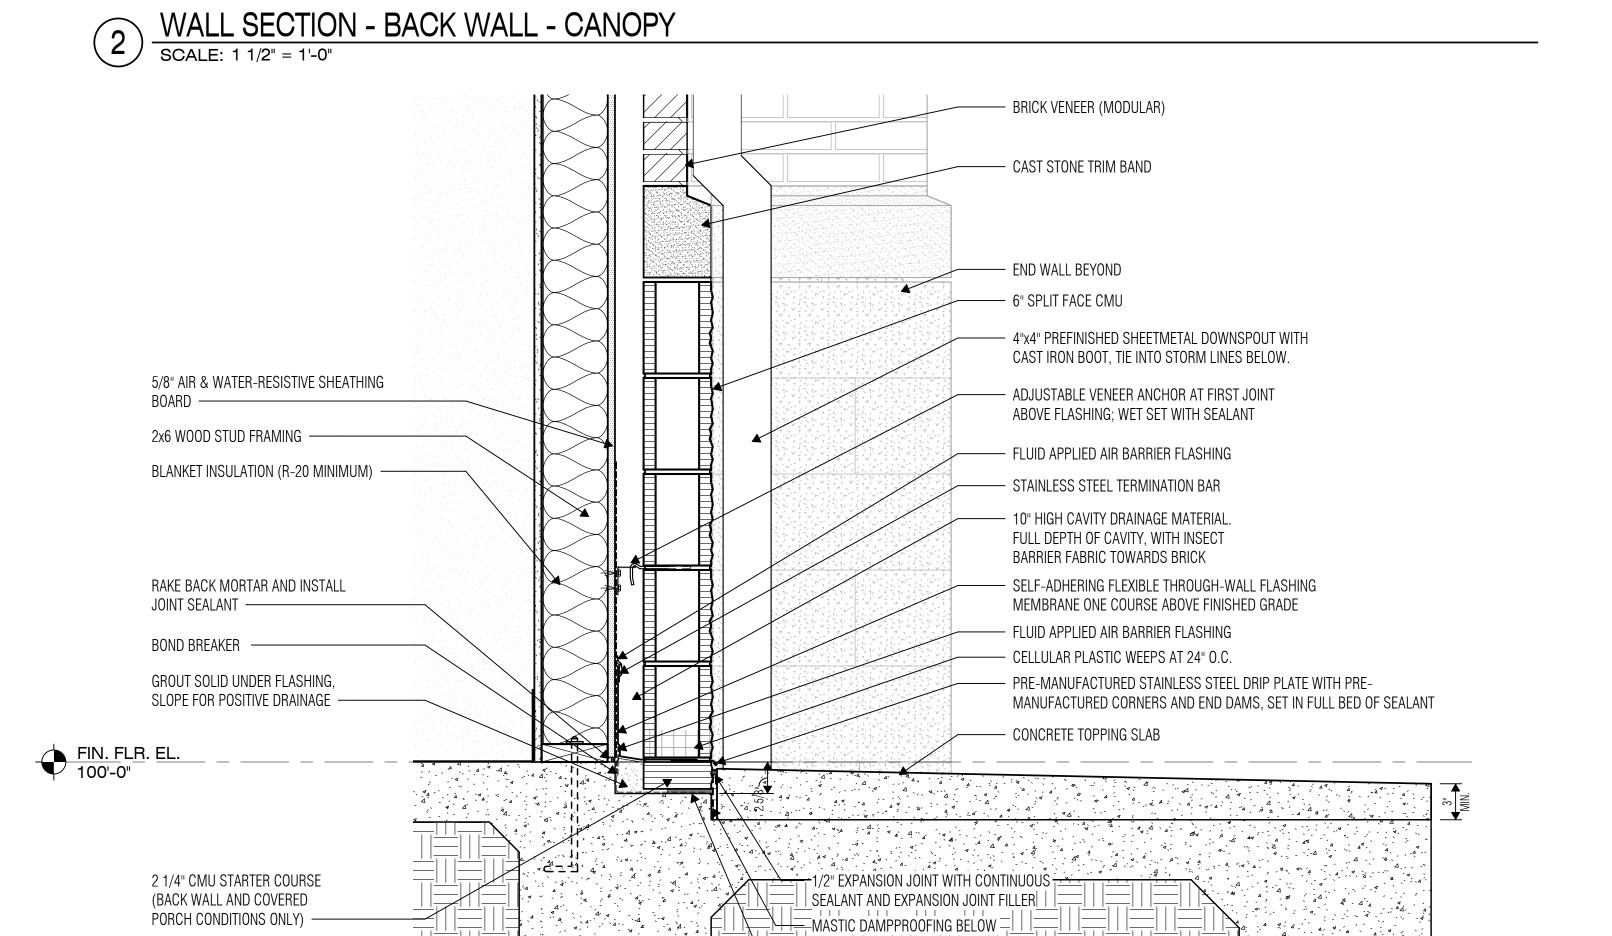

- R-23.0 MIN. VENTED NAIL BASE

RIDGED INSULATION

- PLYWOOD ROOF DECK

P,

REVISIONS

Approver Designer Quality Control Designer Proj. Arch. Checker

PROJECT NO.


23-018.00

SHEET TITLE

BUILDING ASSEMBLY DETAILS

SHEET NO.

A4.33

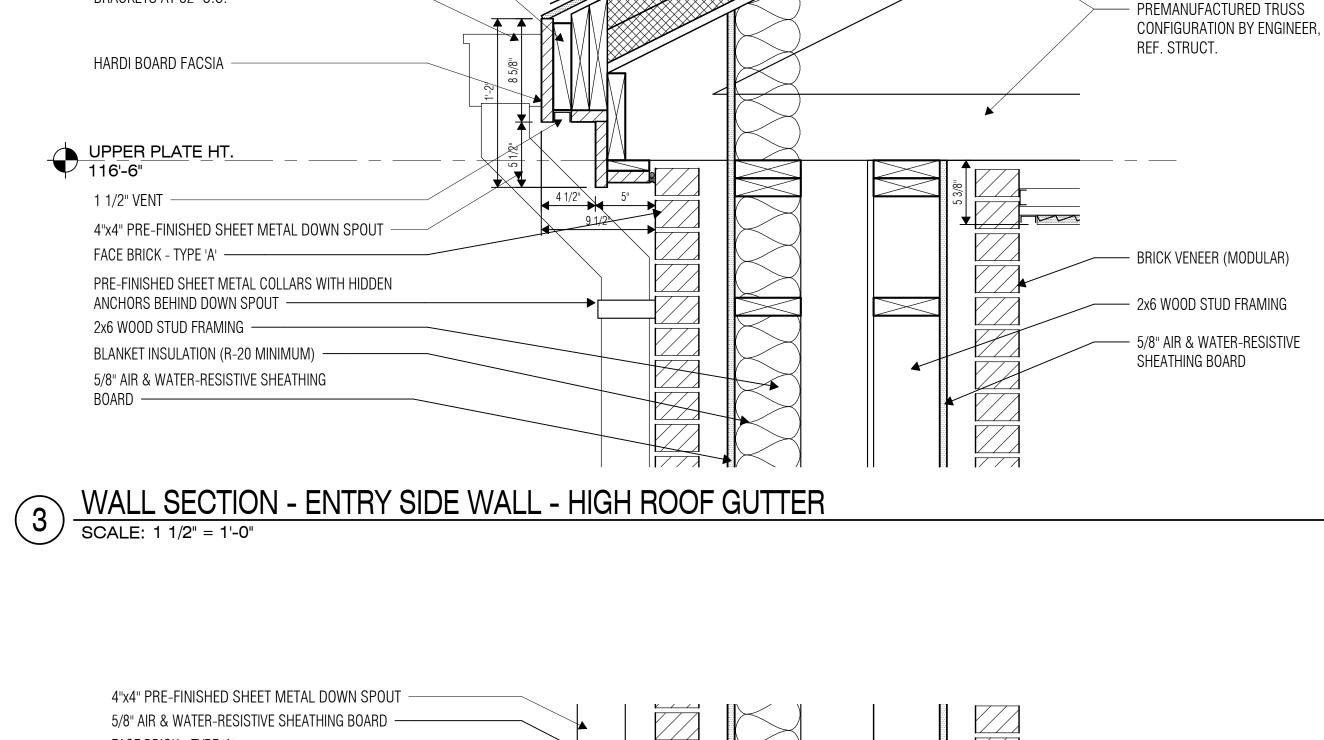


ASPHALT SHINGLES -

BRACKETS AT 32" O.C. -


2x BLOCKING WITH 1 1/2" AIR SPACE

CONTINUOUS 5"x5" PRE-FINISHED SHEET

METAL GUTTER WITH DECK HANGERS AND

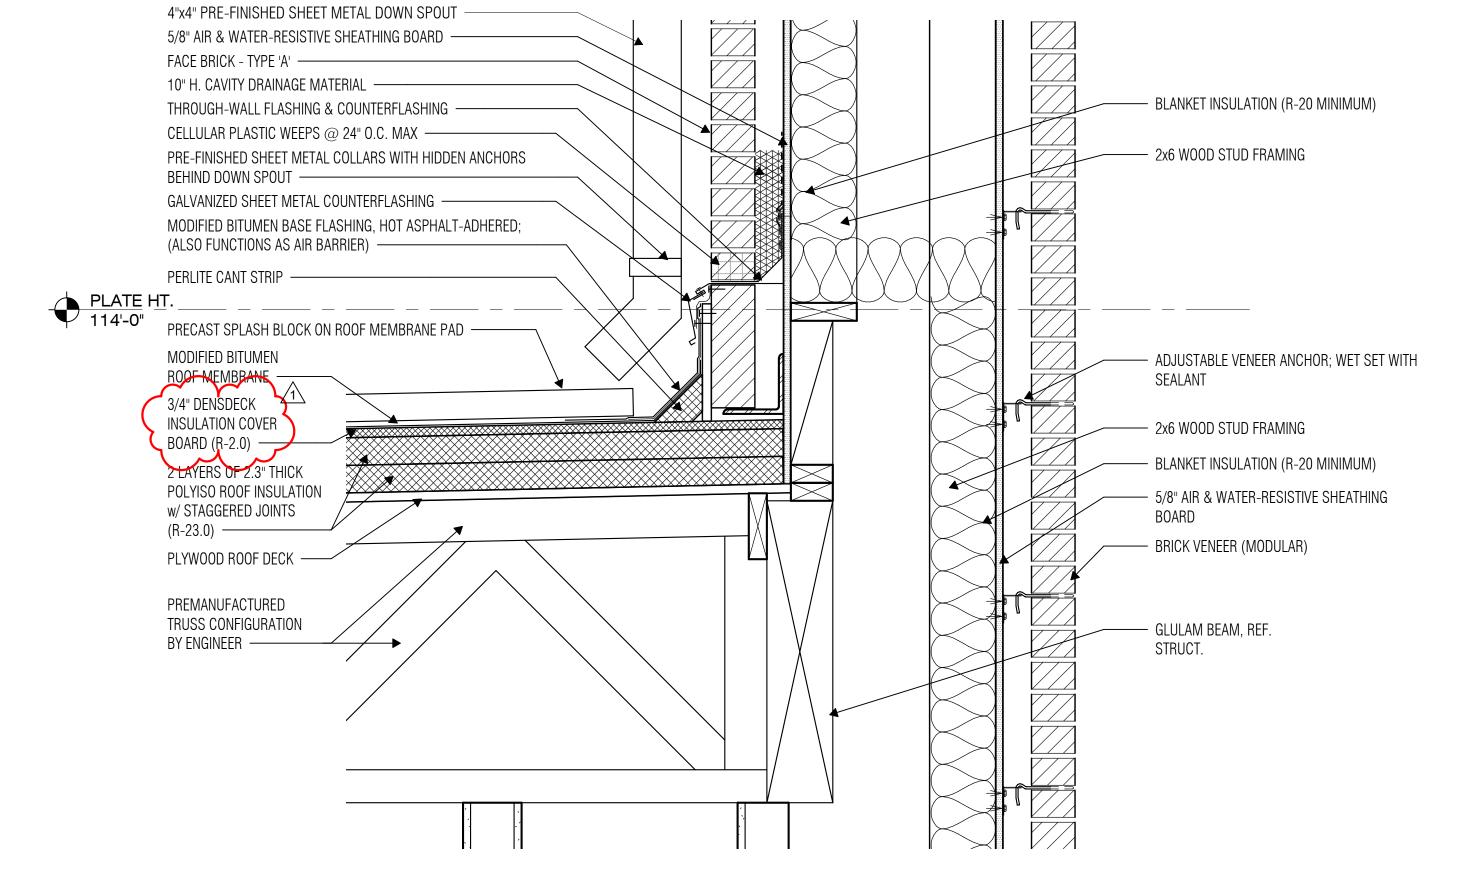



WALL SECTION - ENTRY SIDE WALL -LOW ROOF SCALE: 1 1/2" = 1'-0"

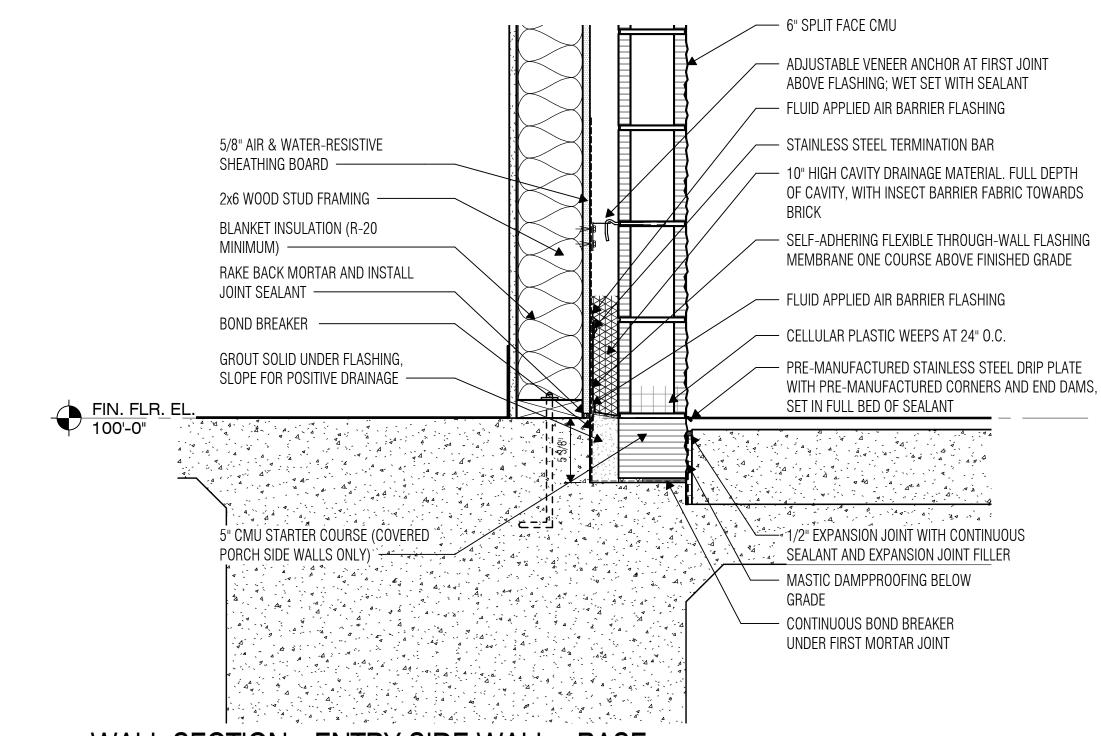

WALL SECTION - ENTRY SIDE WALL - BASE

SCALE: 1 1/2" = 1'-0"

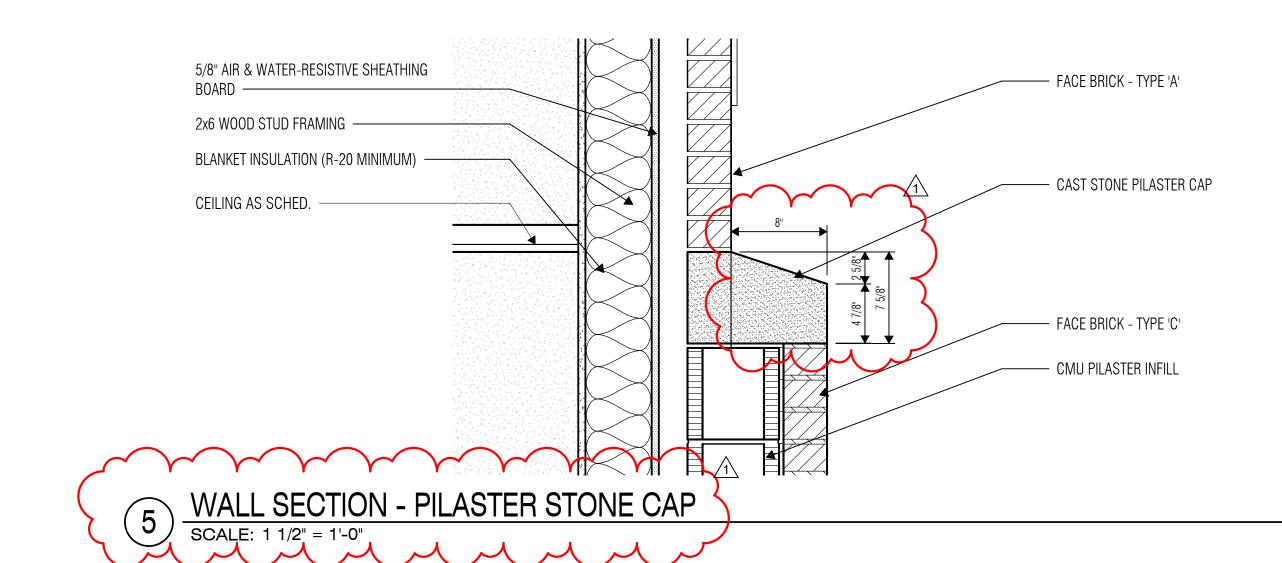

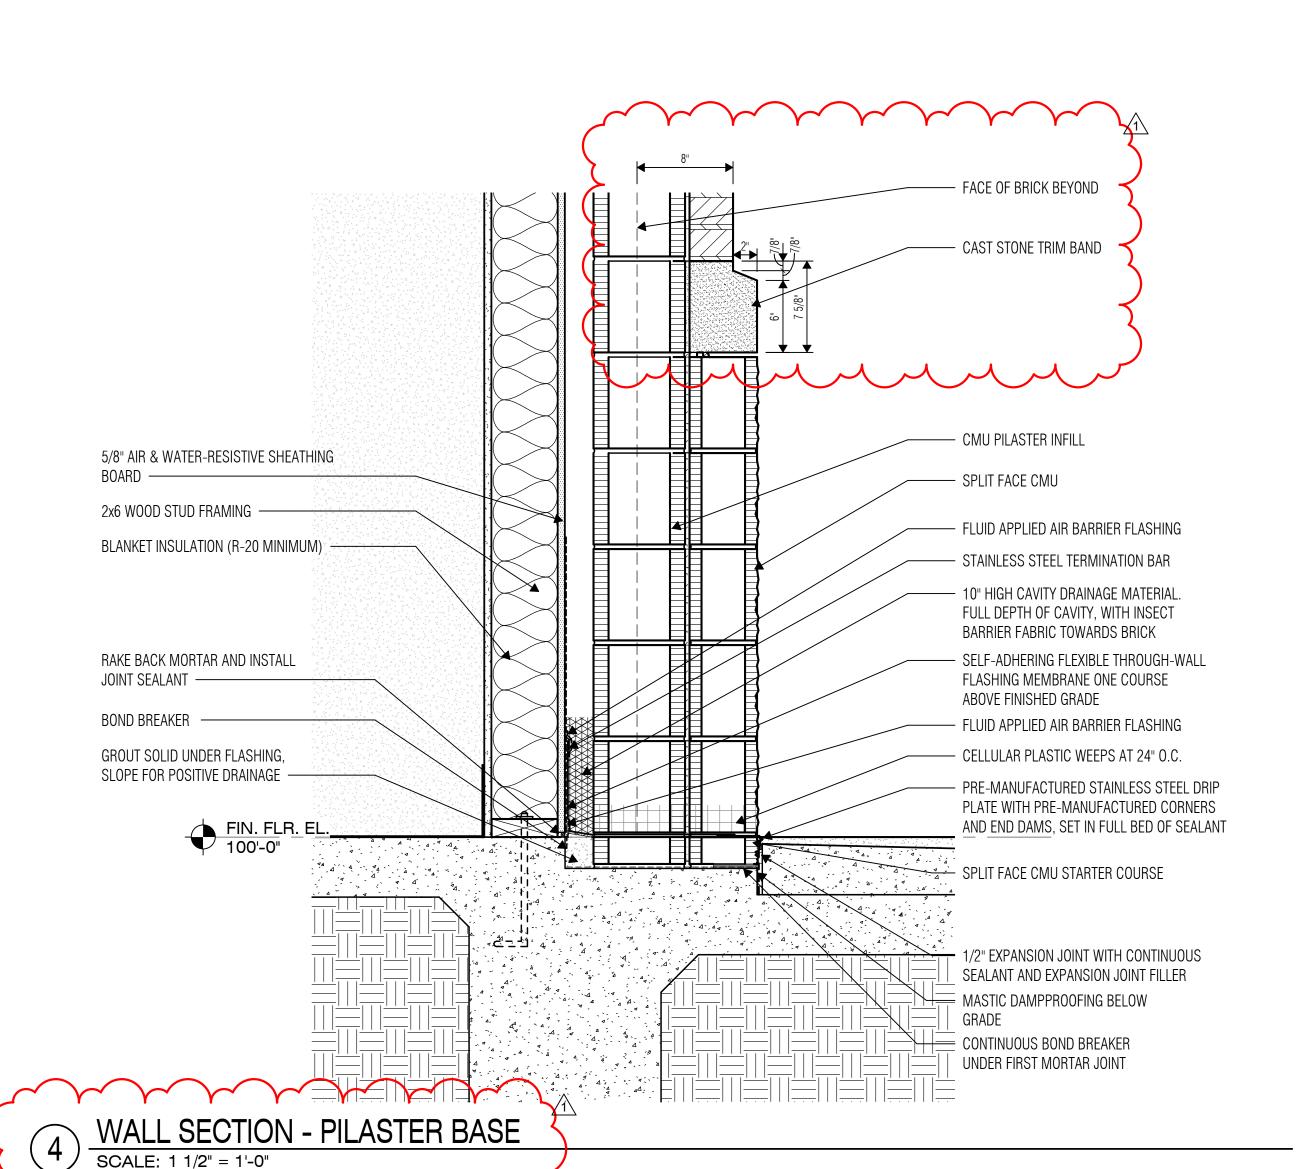

<u>Р</u>

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Approver Author
Designer Quality Control
Designer
Proj. Arch.
Checker


PROJECT NO. 23-018.00

SHEET TITLE

BUILDING ASSEMBLY DETAILS

SHEET NO.

A4.34

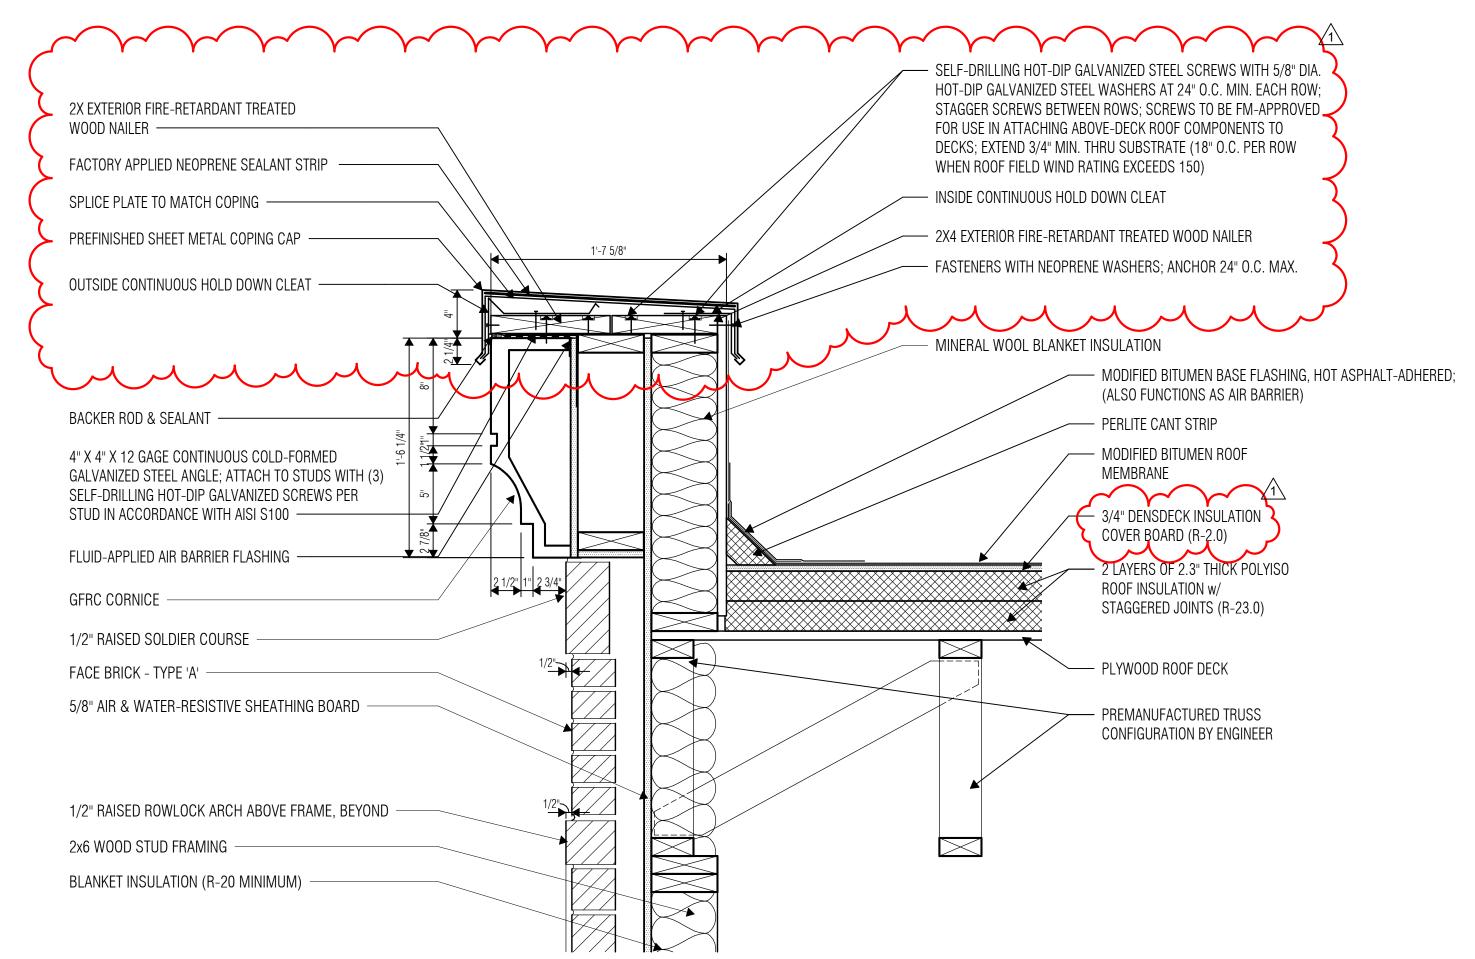

WALL SECTION - CONFERENCE STOREFRONT - PARAPET

WALL SECTION - CONFERENCE STOREFRONT - SF HEAD

FLUID-APPLIED AIR BARRIER FLASHING ——— STAINLESS STEEL TERMINATION BAR -SELF-ADHERING FLEXIBLE THROUGH-WALL FLASHING BLANKET INSULATION (R-20 MIN.) MEMBRANE ---SOLDIER COURSE ARCH INFILL BRICK — 2x6 WOOD STUD FRAMING 10" H. CAVITY DRAINAGE MATERIAL. FULL DEPTH OF CAVITY, WITH INSECT BARRIER FABRIC TOWARDS BRICK — FLUID-APPLIED AIR BARRIER FLASHING — GALVANIZED SHEET METAL FLASHING, FASTEN TO STUDS AT - 5/8" AIR & WATER-RESISTIVE SHEATHING BOARD 16" O.C. MIN. ——— 1/2" RAISED ROWLOCK BRICK ARCH FRAME; BEYOND -CELLULAR PLASTIC WEEPS AT FIRST VERTICAL JOINT FROM EACH END OF WINDOW OPENING, THEN EQUALLY SPACED OVER OPENING AT 24" O.C. MAX — - FLUID-APPLIED AIR BARRIER FLASHING INSTALL BOTTOM OF STEEL LINTEL ABOVE BRICK JOINT AND - BACKER ROD AND SEALANT PROVIDE CUT LIP BRICK HEADER CONDITION; 3/4" MIN. LIP —— - COMPRESSIBLE MINERAL WOOL INSULATION AT SHIM SPACE PRE-MANUFACTURED STAINLESS STEEL DRIP PLATE W/ PRE- APPLY SEALANT AT ALL FASTENERS AND ANCHORS MANUFACTURED END DAMS, SET IN FULL BED OF SEALANT —— BACKER ROD & SEALANT — THERMALLY BROKEN ALUMINUM STOREFRONT WITH INSULATED GLAZING


FACE OF BRICK BEYOND -1/2" RAISED ROWLOCK BRICK FRAME, APPLY SEALANT AT ALL FASTENERS THERMALLY-BROKEN ALUMINUM 3.5/8"-TO FACE STOREFRONT WITH INSULATED GLAZING -AND ANCHORS PERMANENT PLASTIC SHIMS AT COMPRESSIBLE MINERAL WOOL EACH ANCHOR -INSULATION AT SHIM SPACE HIGH-PERFORMANCE SILL FLASHING - BACKER ROD & SEALANT WITH THERMAL BREAK AND END DAMS - 1/2" SOLID SURFACE (SLD-01) WINDOW SILL; EXTEND FRONT APRON 1" PAST EACH BACKER ROD & SEALANT SIDE OF OPENING · MITER TURN RADIUSED DETAIL EACH SIDE OF WINDOW & RETURN TO WALL - 3/4" MARINE GRADE PLYWOOD FLUID-APPLIED AIR BARRIER FLASHING CAST STONE SILL - FLUID-APPLIED BARRIER FLASHING 5/8" AIR- & WATER-RESISTIVE SHEATHING BOARD -SELF-ADHERING FLEXIBLE THROUGH-WALL FLASHING MEMBRANE ONE COURSE ABOVE - 10" HIGH CAVITY DRAINAGE MATERIAL FULL DEPTH OF CAVITY, WITH INSECT CELLULAR PLASTIC WEEPS BARRIER FABRIC TOWARDS BRICK AT 24" O.C. — PRE-MANUFACTURED STAINLESS STEEL DRIP ─ 6" RUBBER BASE PLATE W/ PRE-MANUFACTURED CORNERS AND END DAMS, SET IN FULL BED OF SEALANT -FIN. FLR. EL. RAKE BACK MORTAR AND INSTALL JOINT SEALANT -**BOND BREAKER** GROUT SOLID UNDER FLASHING, SLOPE FOR POSITIVE DRAINAGE CONTINUOUS BOND BREAKER
UNDER FIRST MORTAR JOINT -

WALL SECTION - CONFERENCE STOREFRONT - SF

3 SILL/BASE


SCALE: 1 1/2" = 1'-0"

SCALE: 1 1/2" = 1'-0"

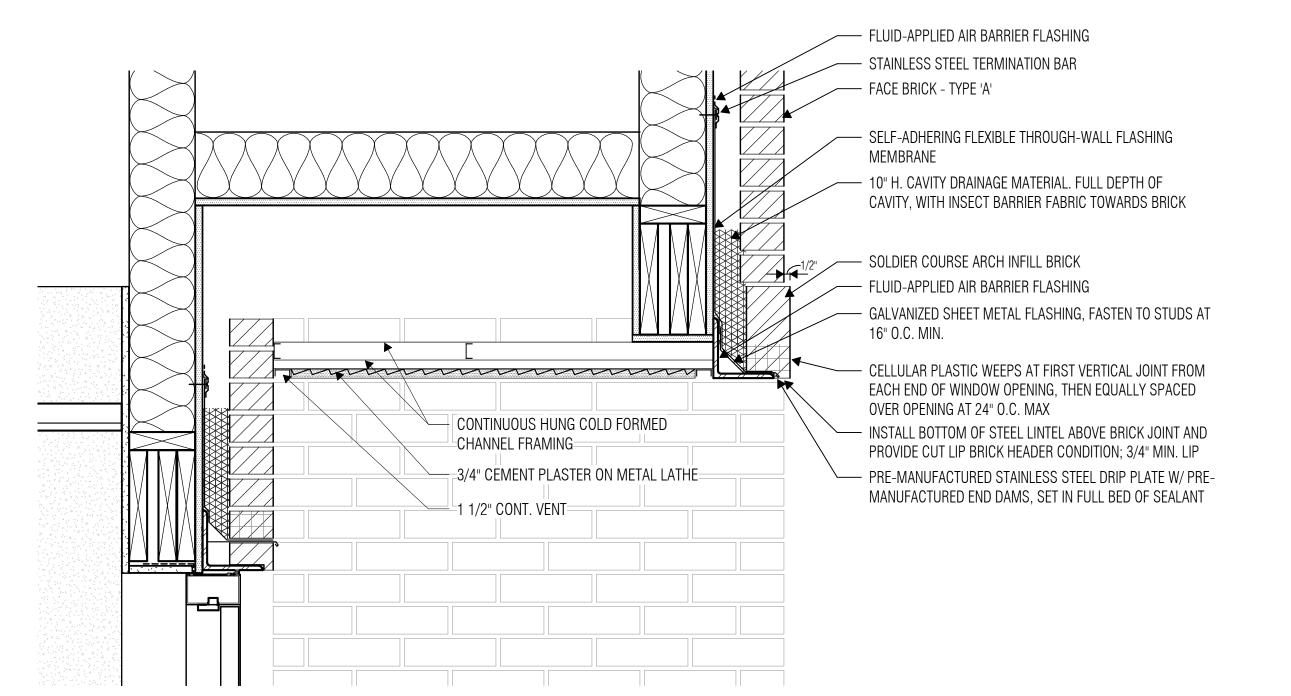

WALL SECTION - KITCHEN DOOR SET BACK - CANOPY

SCALE: 1 1/2" = 1'-0"

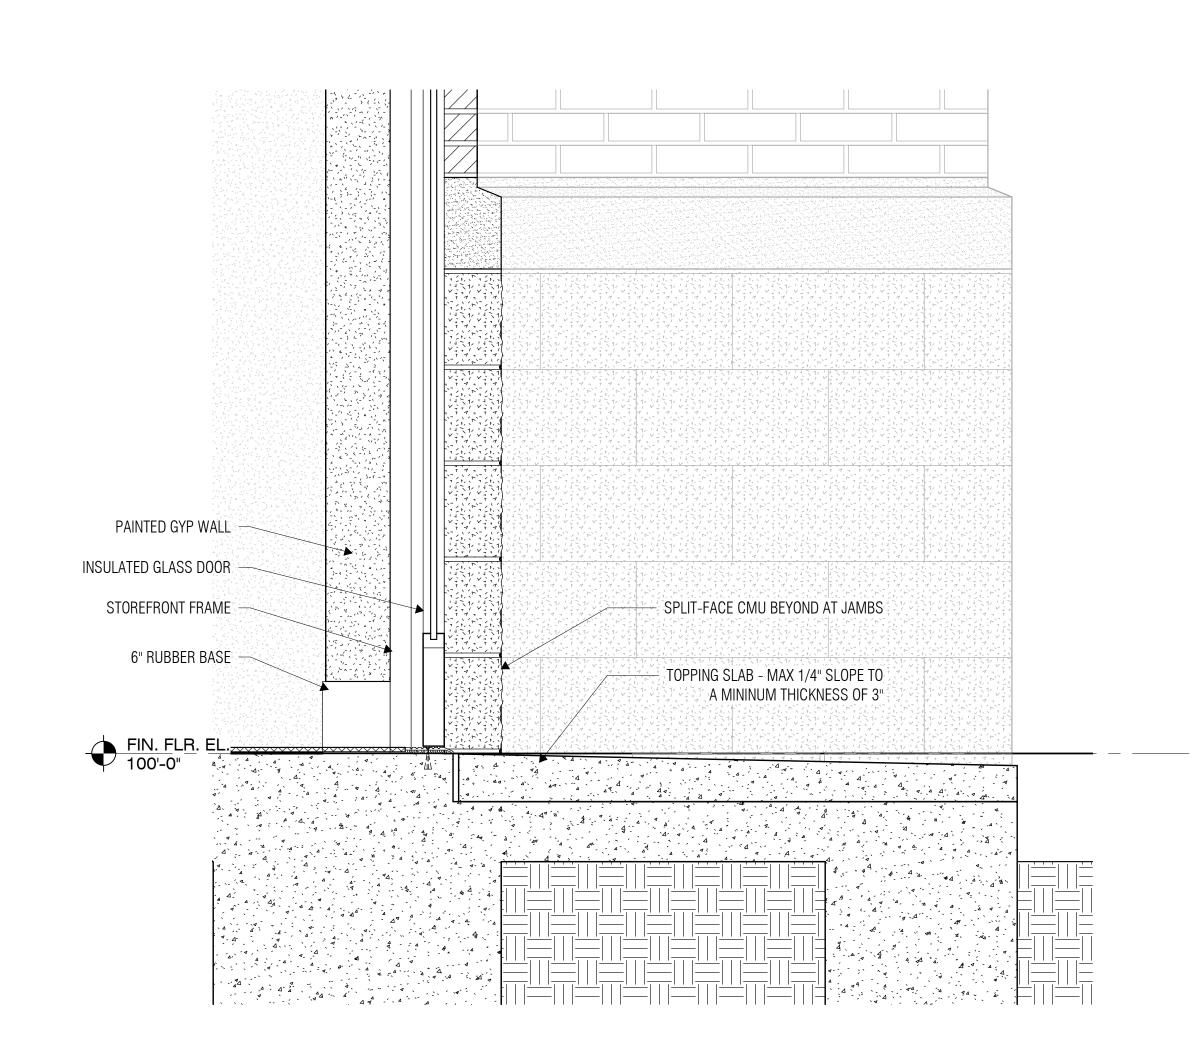

WALL SECTION - KITCHEN DOOR SET BACK - DOOR SILL

SCALE: 1 1/2" = 1'-0"

Director Author Approver Designer Quality Control Designer Proj. Arch. Checker

> PROJECT NO. 23-018.00


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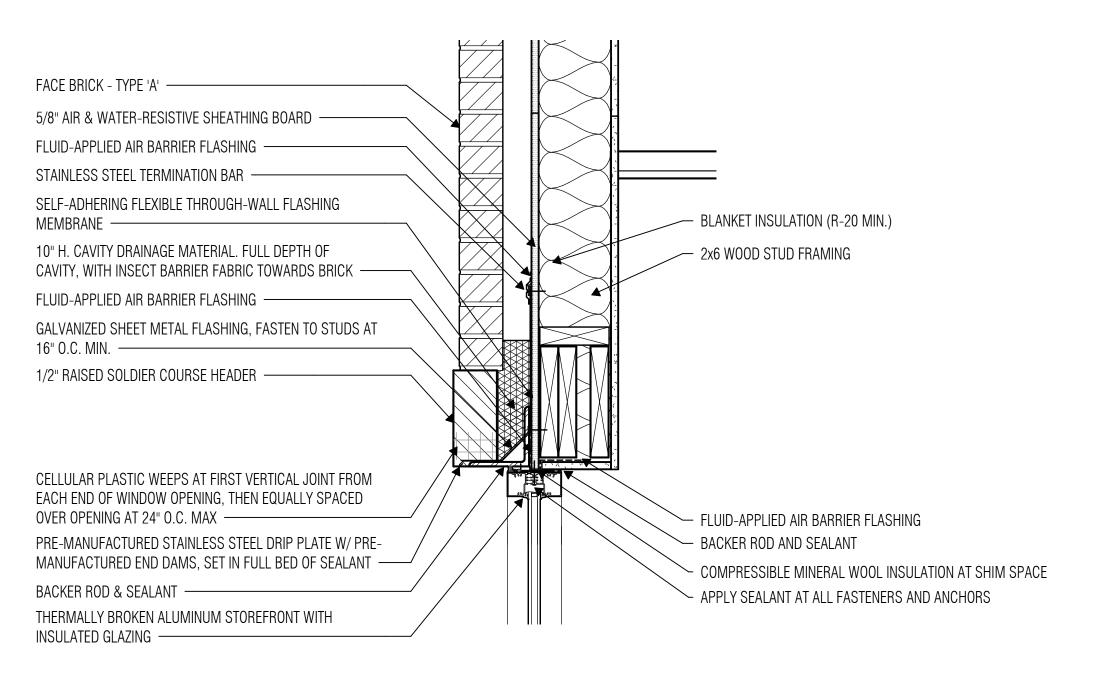
BUILDING ASSEMBLY DETAILS

SHEET NO.


A4.35


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WALL SECTION - BACK WALL STOREFRONT - SF HEAD



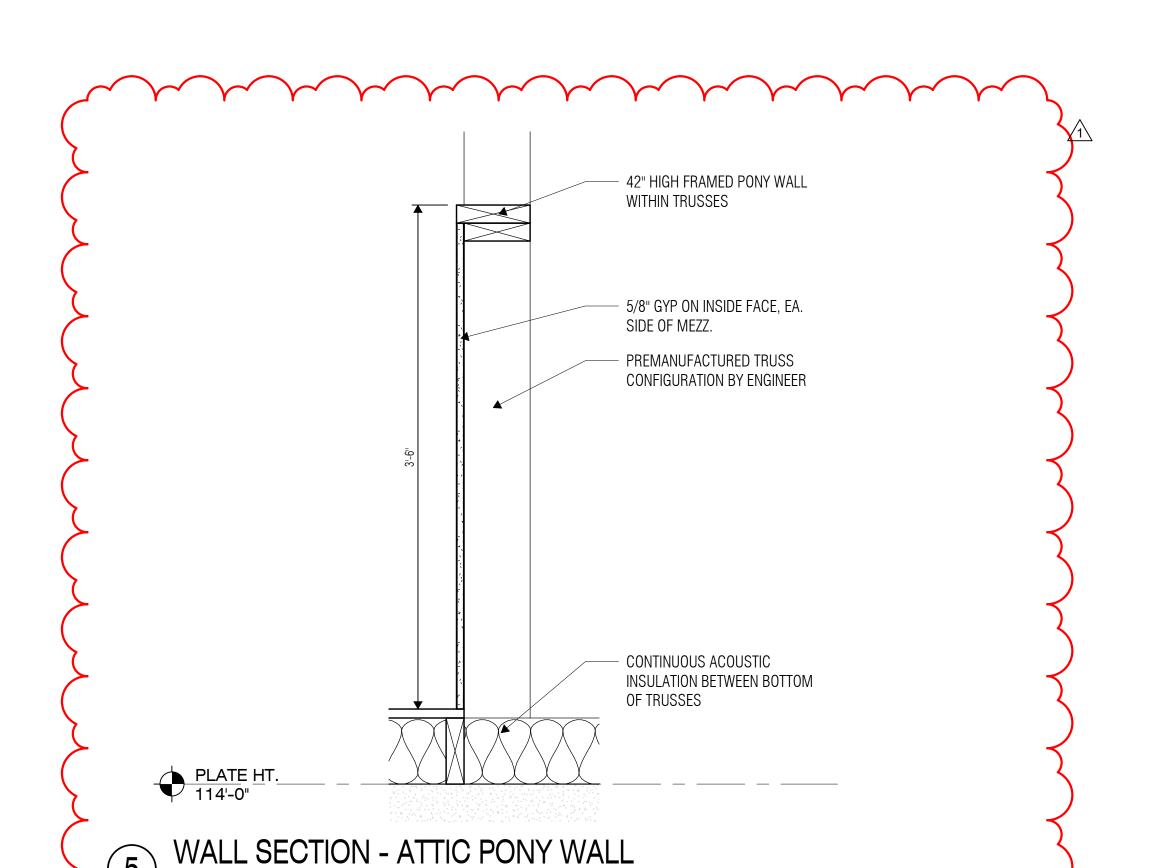

1'-6 1/2"

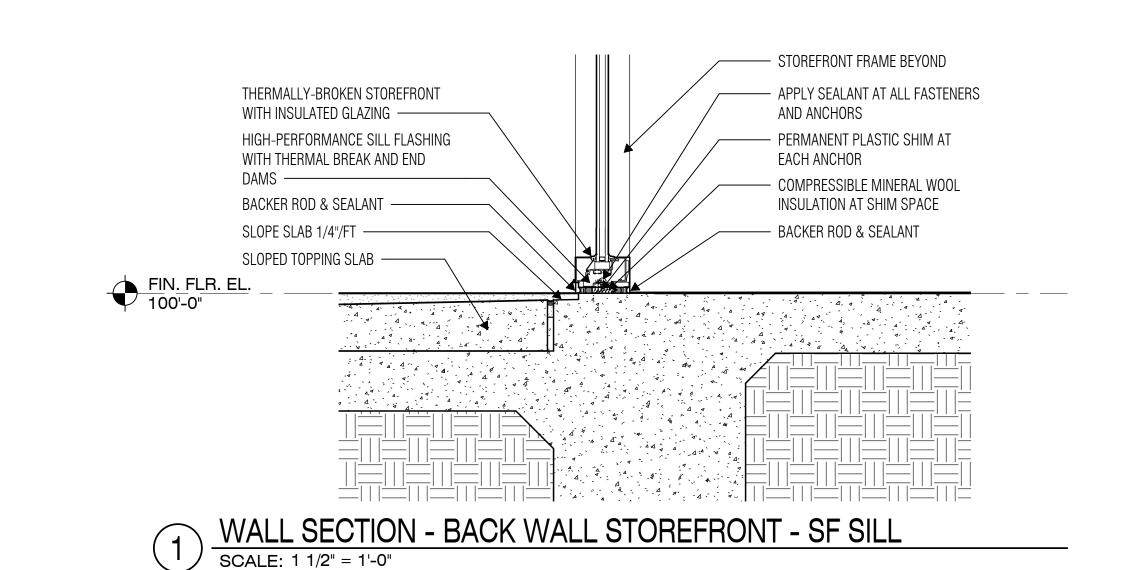2X EXTERIOR FIRE-RETARDANT TREATED

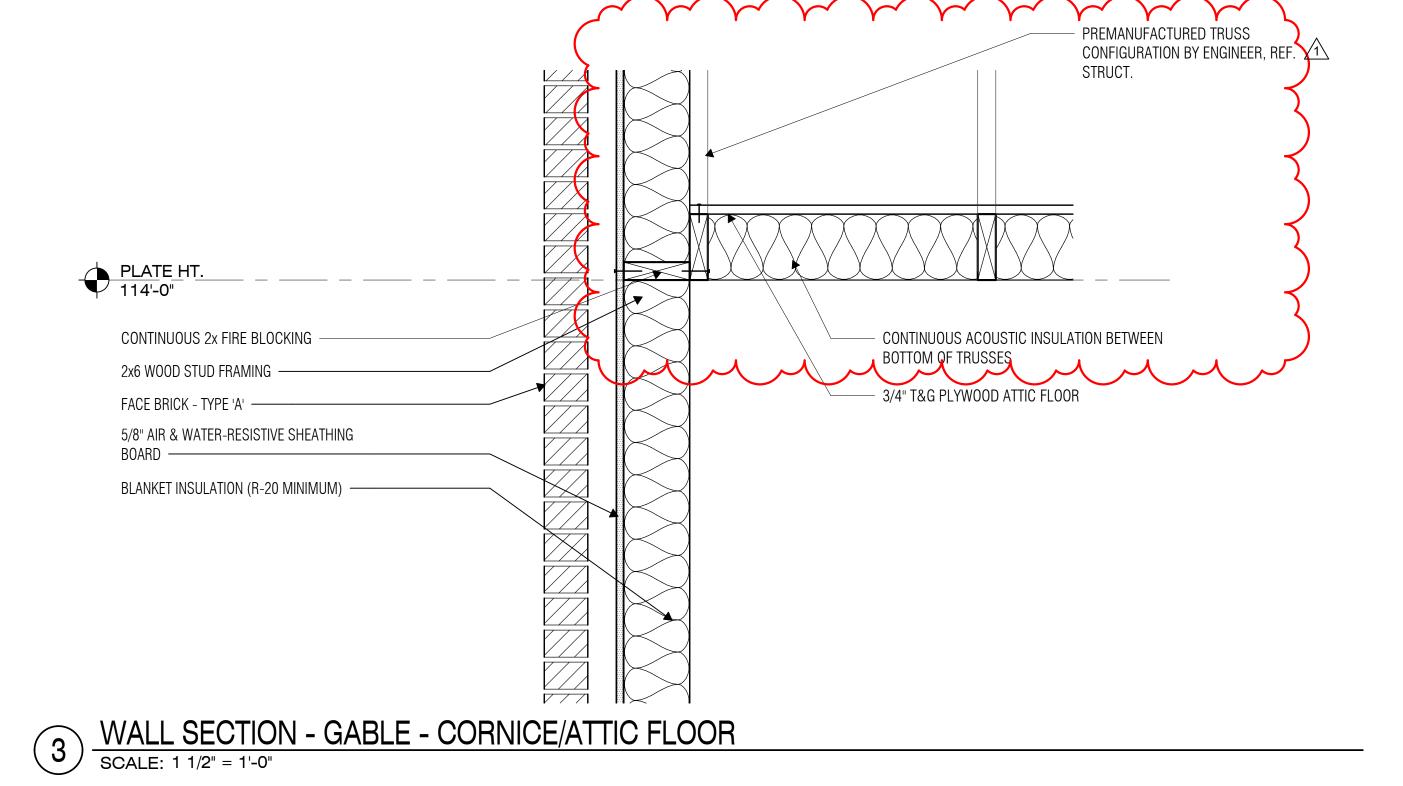SPLICE PLATE TO MATCH COPING —

PREFINISHED SHEET METAL COPING CAP —

OUTSIDE CONTINUOUS HOLD DOWN CLEAT

4" X 4" X 12 GAGE CONTINUOUS COLD-FORMED

STUD IN ACCORDANCE WITH AISI S100 —

FLUID-APPLIED AIR BARRIER FLASHING —

OF VENEER; WET SET WITH SEALANT -

5/8" AIR & WATER-RESISTIVE SHEATHING

BLANKET INSULATION (R-20 MINIMUM) —

WALL SECTION - GABLE - ROOF

SCALE: 1 1/2" = 1'-0"

2x6 WOOD STUD FRAMING -

FACE BRICK - TYPE 'A' -----

GALVANIZED STEEL ANGLE; ATTACH TO STUDS WITH (3)

SELF-DRILLING HOT-DIP GALVANIZED SCREWS PER

ADJUSTABLE VENEER ANCHOR WITHIN 12" FROM TOP

FACTORY APPLIED NEOPRENE SEALANT STRIP ———

WOOD NAILER ——

BACKER ROD & SEALANT

GELF-DRILLING HOT-DIP GALVANIZED STEEL SCREWS WITH 5/8" DIA.

HOT-DIP GALVANIZED STEEL WASHERS AT 24" O.C. MIN. EACH ROW;

STAGGER SCREWS BETWEEN ROWS; SCREWS TO BE FM-APPROVED

FOR USE IN ATTACHING ABOVE-DECK ROOF COMPONENTS TO DECKS; EXTEND 3/4" MIN. THRU SUBSTRATE (18" O.C. PER ROW

FASTENERS WITH NEOPRENE WASHERS; ANCHOR 24" O.C. MAX.

- ASPHALT SHINGLES

- R-23.0 MIN. VENTED NAIL

- CUT NAIL BASE BACK AT

VENT FOR CONTINUOUS

PATH OF AIR

- RIDGE BLOCKING BETWEEN TRUSSES

— ROOF DECK

BASE RIDGED INSULATION

WHEN ROOF FIELD WIND RATING EXCEEDS 150)

— 2X4 EXTERIOR FIRE-RETARDANT TREATED WOOD NAILER

- INSIDE CONTINUOUS HOLD DOWN CLEAT

- MINERAL WOOL BLANKET INSULATION

- PREFINISHED SHEET METAL STEP FLASHING

ROOF PLAN NOTES

mounting rails, and other miscellaneous roof penetrations as required to shed

ROOF PLAN LEGEND

DSC DOWNSPOUT WITH SCUPPER AND CONDUCTOR

SB SPLASH BLOCK, CONCRETE, REF. 4/A5.11

OS OVERFLOW SCUPPER, REF. 6/A5.11 DS DOWNSPOUT, REF. 3&5/A5.11

HEAD, REF. 2/A5.11

1. Provide tapered insulation crickets at the high side of all rooftop curbs,

P, DE

Director Drawn By Approver Author Designer Quality Control Designer Proj. Arch. Checker

PROJECT NO.


23-018.00

SHEET TITLE


OVERALL ROOF PLAN

SHEET NO.


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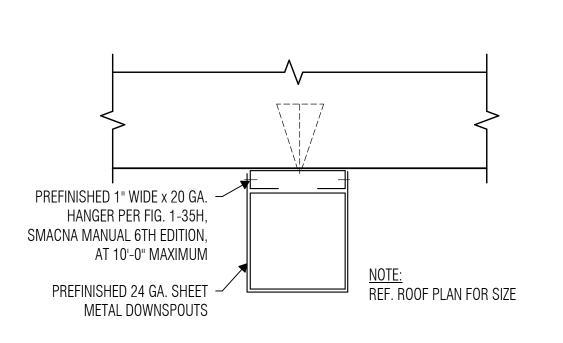
ROOF PLAN SCALE: 1/8" = 1'-0"

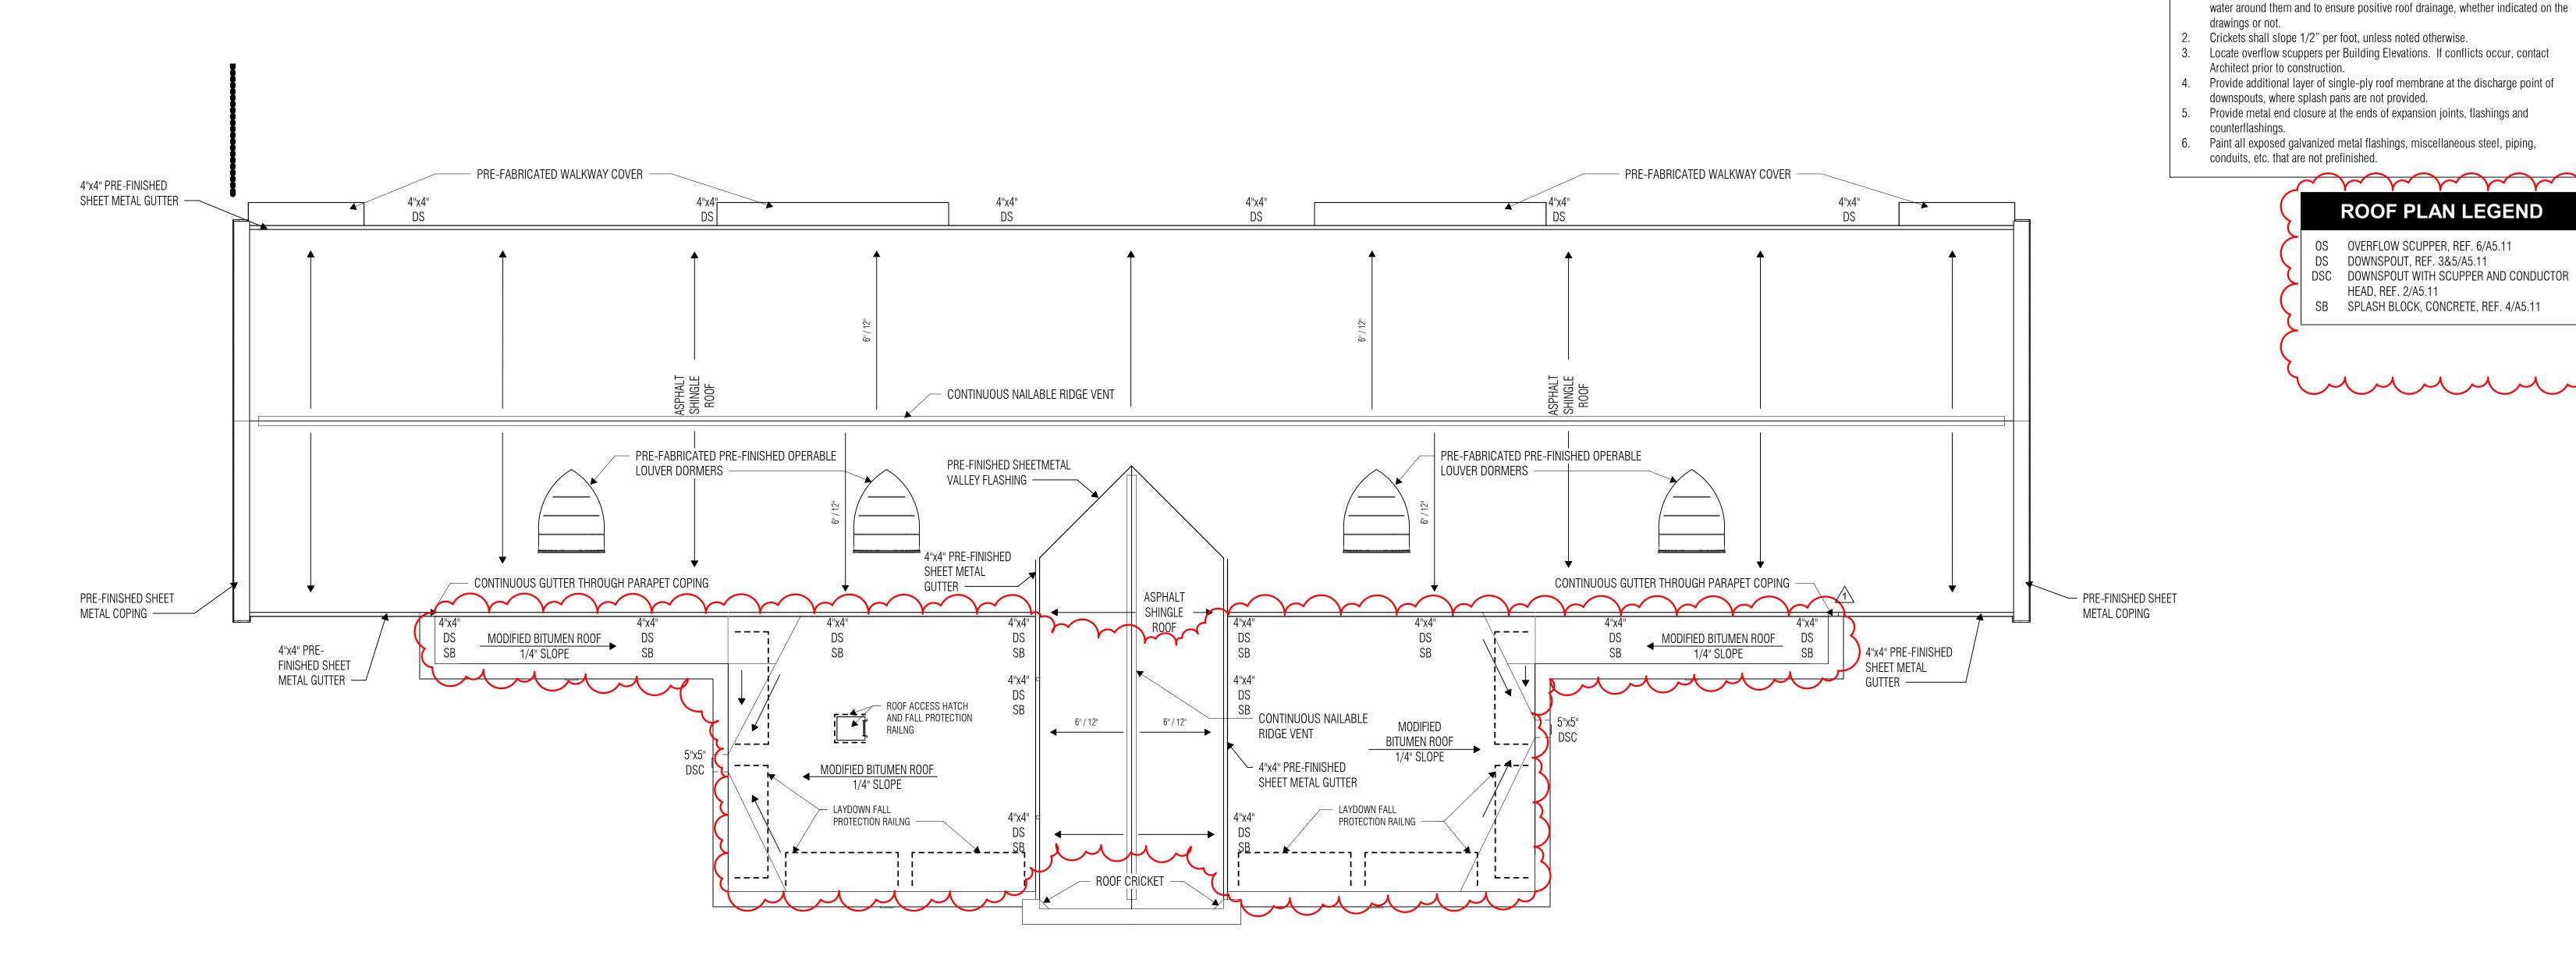

2 CONDUCTOR HEAD NO OVERFLOW_RECT DOWNSPOUT
SCALE: 1 1/2" = 1'-0"

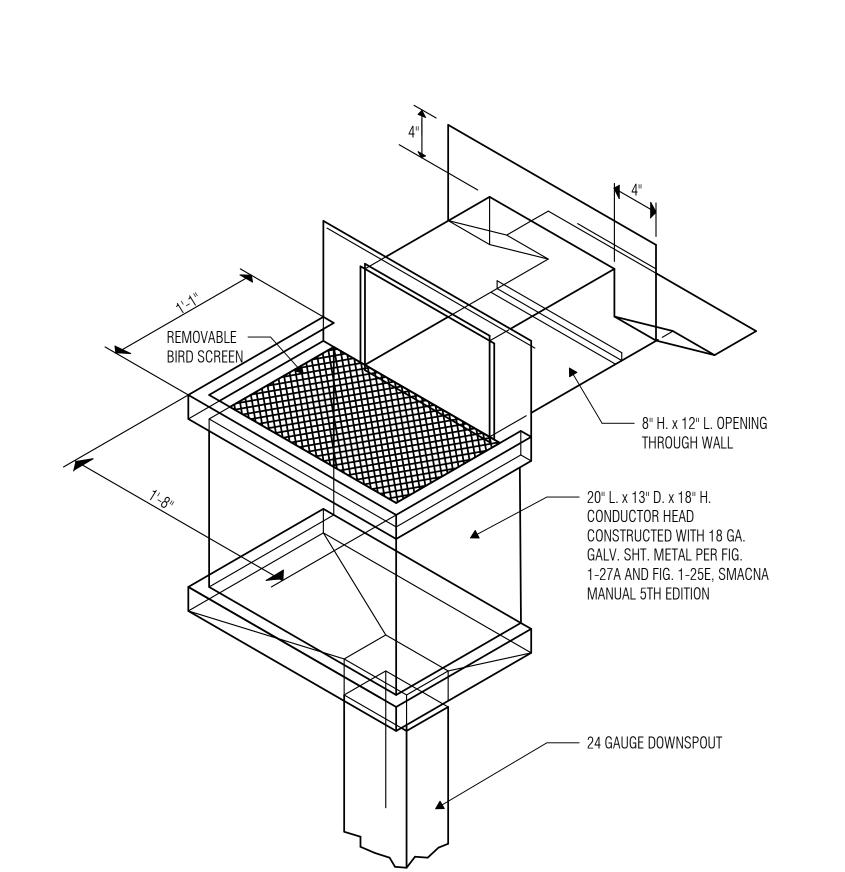



MC611 - DOWNSPOUT BOOT

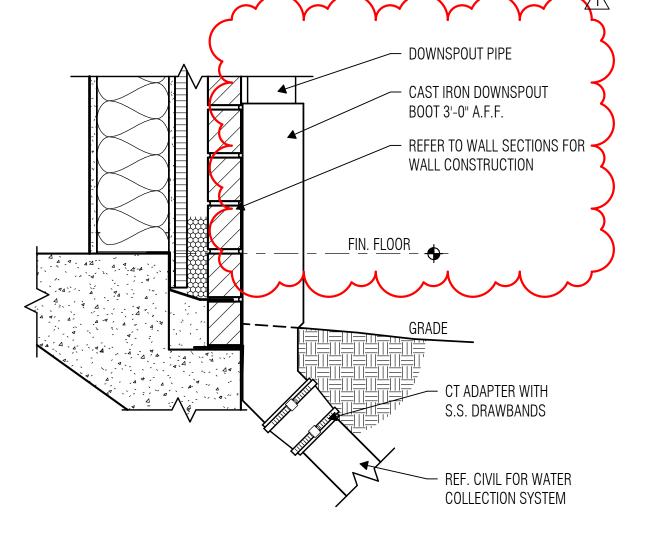

5 R711 - RECT DOWNSPOUT PLAN

SCALE: 3" = 1'-0"

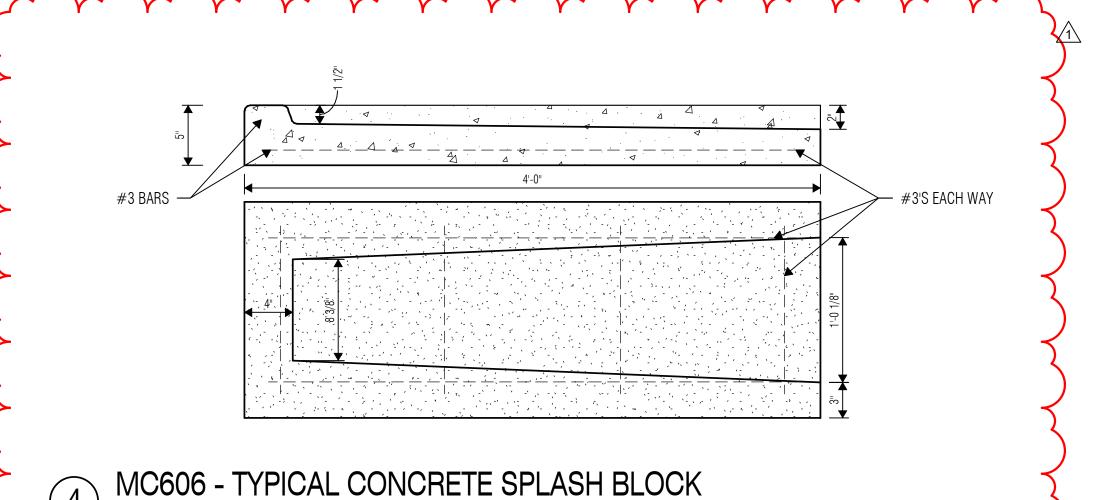

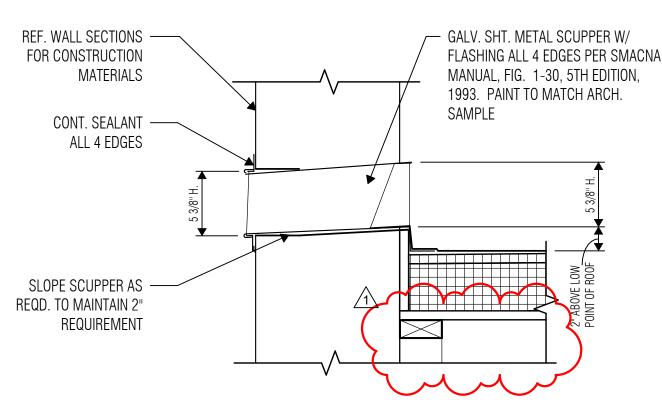

6 OVERFLOW SCUPPER GENERIC SINGLE-PLY ROOFING SCALE: 1 1/2" = 1'-0"

ISSUED: FEB 29, 2024 **REVISIONS**

Revision Date Revision No. 03-19-2024 1 Addendum 01

Drawn By

Director Author Approver Designer Quality Control Designer Proj. Arch.

L 1 1/2" HALF ROUND CEMENT_

PLASTER

MOLDING


Checker PROJECT NO.

23-018.00 SHEET TITLE

REFLECTED CEILING PLAN

SHEET NO.

A6.11

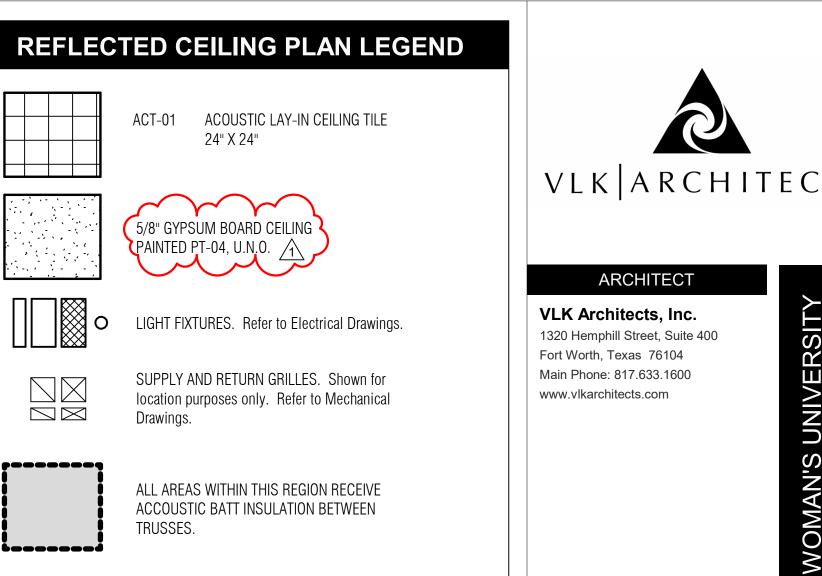

REFLECTED CEILING PLAN **NOTES**

NON-RATED PARTITION TO DECK. Extend partition to

24" X 24"

 \square

Drawings.

TRUSSES.


••••• WALLS EXTEND TO BOTTOM OF TRUSS

PTD —— deck above. Brace partitions per Floor Plan General

- All ceiling heights shall be 9'-0" A.F.F. unless noted otherwise. Refer to Detail 6/A6.31 for Typical Gypsum Board Ceiling Control Joint Detail. Refer to Detail 7/A6.31 for Typical Plaster Ceiling Control Joint Detail. Provide vented reveals at perimeter of all non-insulated exterior plaster soffits. Provide venting strips or perforated panels at perimeter of all non-insulated metal panel soffits (refer to Detail 8/A6.31). Venting at non-insulated soffits shall be provided whether specifically indicated on the drawings or not. 5. Provide partition to deck (PTD) at walls surrounding spaces with exposed
- structure. Refer to Reflected Ceiling Plan Legend for PTD requirements. 6. Provide hold-down clips for all acoustic lay-in ceiling panels at vestibules, at sloped ceilings, at fire-rated ceilings, and within 6 feet of exterior doors without

above highest adjacent ceiling and brace per Floor Plan Legend and Floor Plan

At ceiling furring details, the suspended assemblies, bracing, blocking, etc. shown on the details are for schematic representation only. Provide stable, secure and permanent assemblies at these locations in accordance with recommended light-gage steel framing installation practices. At partitions that do not extend to deck above, extend partition 4" minimum

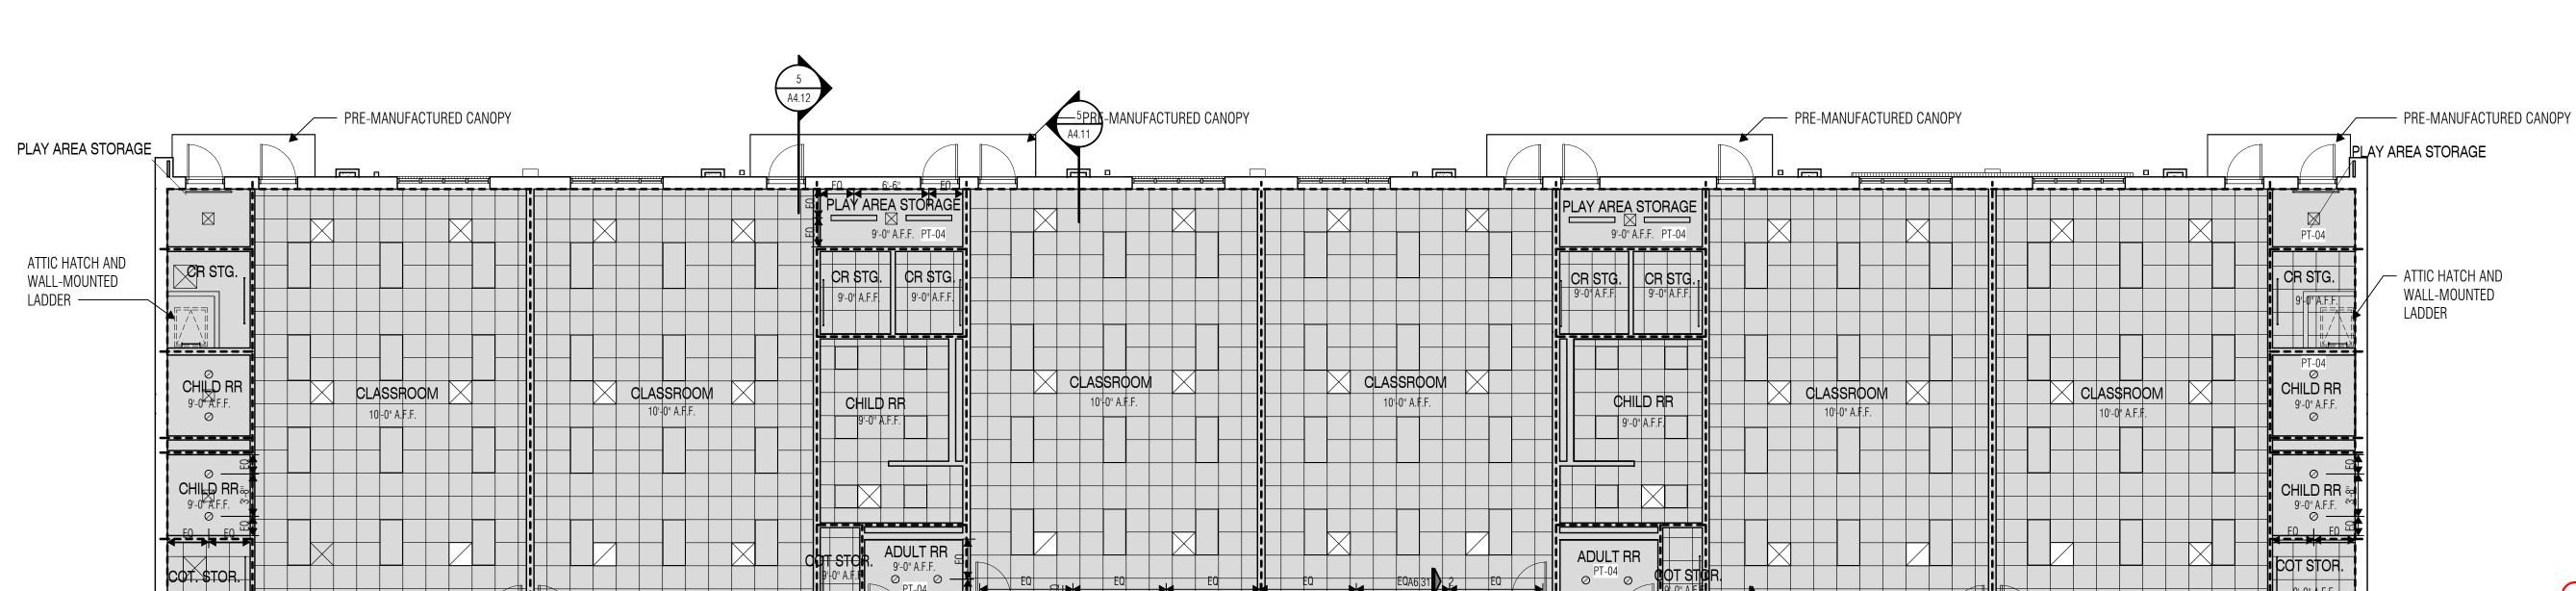

EXTERIOR DECORATIVE PENDANT —

CEMENT PLASTER SOFFIT ————/

MECH/ELEC

└ 1 1/2" HALF ROUND CEMENT


ARCHED CAST STONE TRIM

PLASTER MOLDING

REFLECTED CEILING PLAN

SCALE: 1/4" = 1'-0"

SCALE: 1/8" = 1'-0"

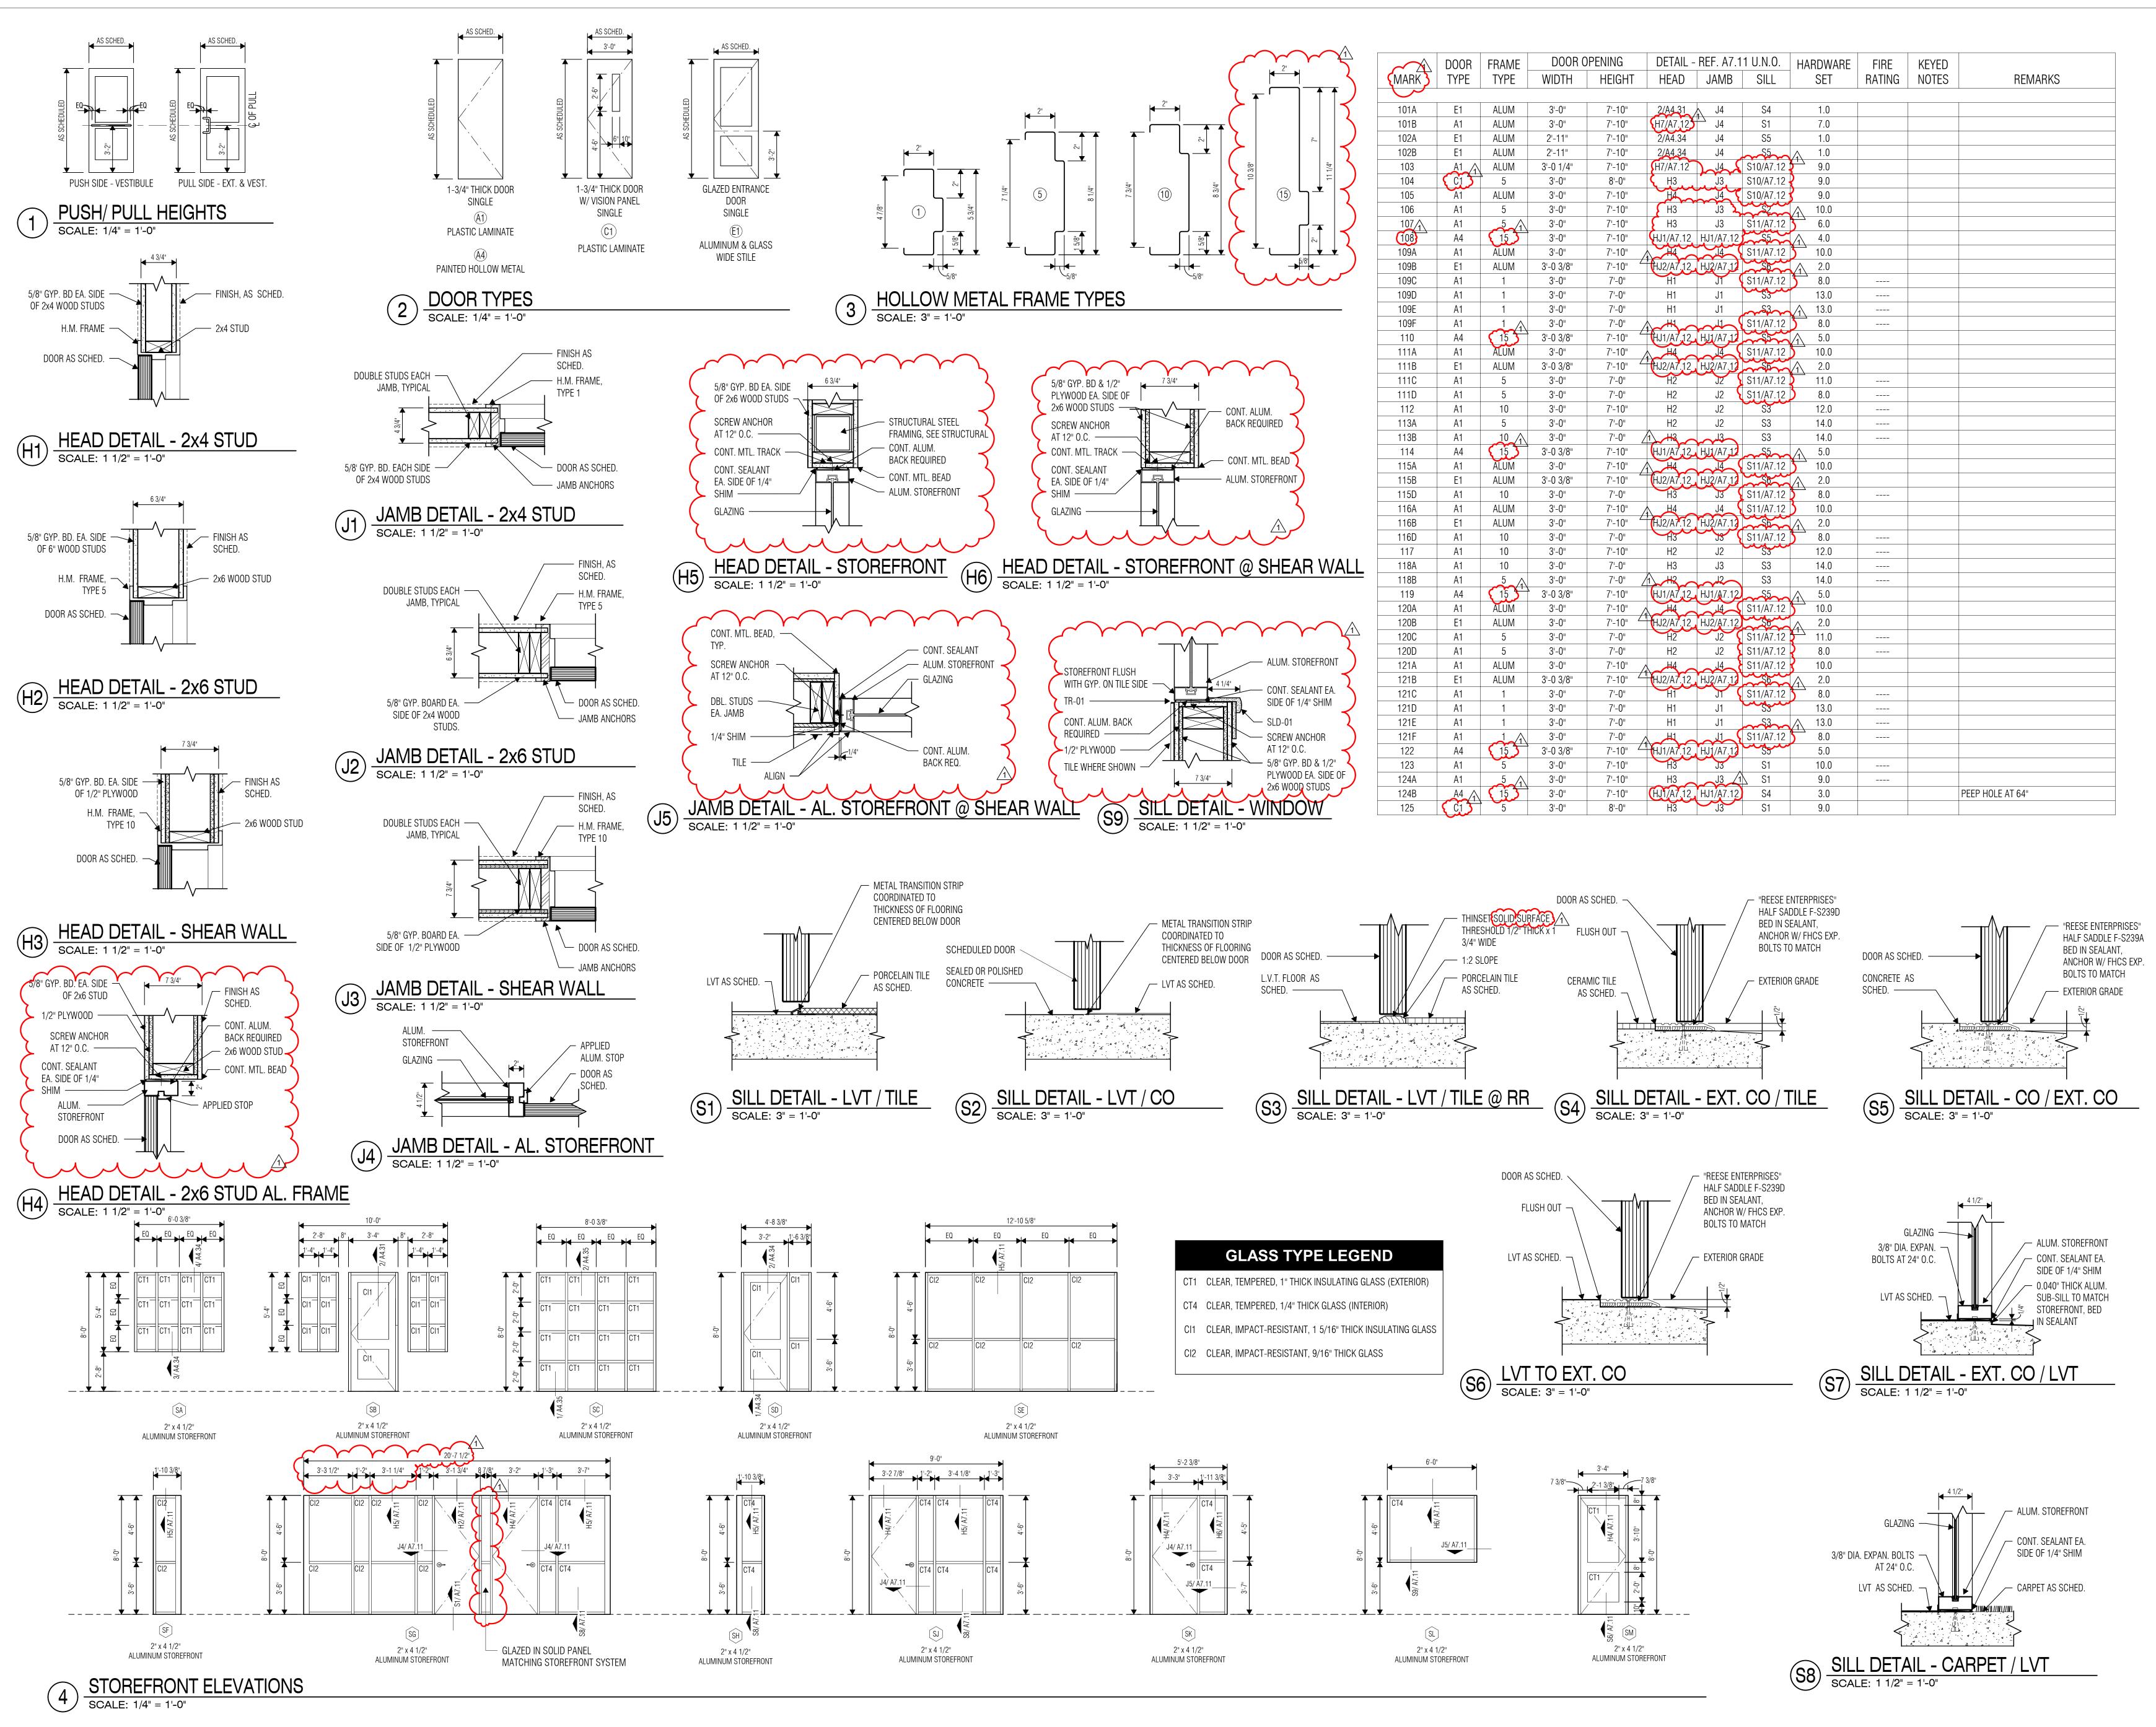

VLK ARCHITECTS

ARCHITECT

VLK Architects, Inc. 1320 Hemphill Street, Suite 400 Fort Worth, Texas 76104 Main Phone: 817.633.1600 www.vlkarchitects.com

ISSUED: FEB 29, 2024

REVISIONS Revision Date Revision No. 03-19-2024 1 Addendum 01

Drawn By Director Author Quality Control

Approver Designer Designer Proj. Arch. Checker

> PROJECT NO. 23-018.00

> > SHEET TITLE

SHEET NO.

DOOR SCHEDULE

A7.11

1320 Hemphill Street, Suite 400


Fort Worth, Texas 76104

www.vlkarchitects.com

Main Phone: 817.633.1600


SHEET TITLE

DOOR & STOREFRONT DETAILS

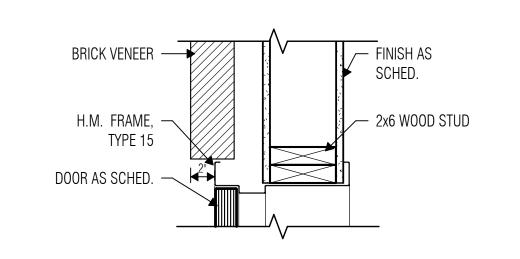


HJ1 HEAD / JAMB DETAIL - EXT. WALL


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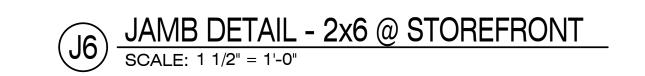
HEAD / JAMB DETAIL - SF. EXT. WALL

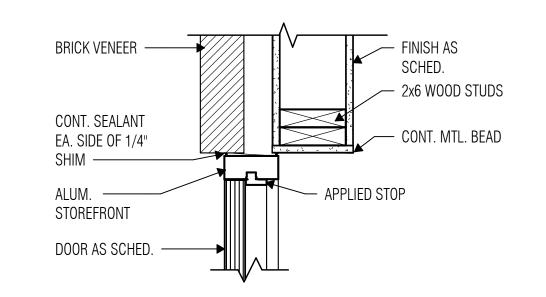
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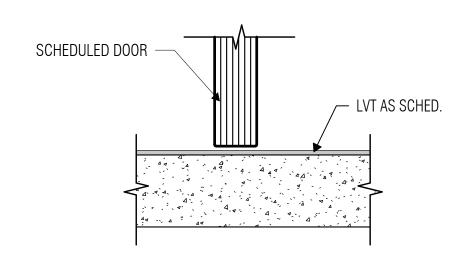





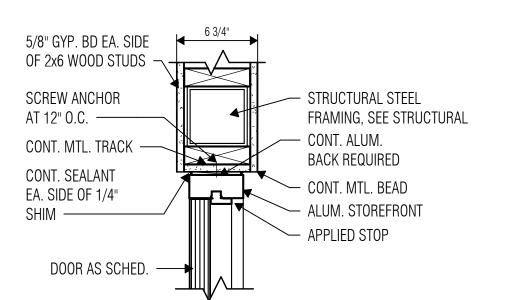



SILL DETAIL - LVT / CARPET

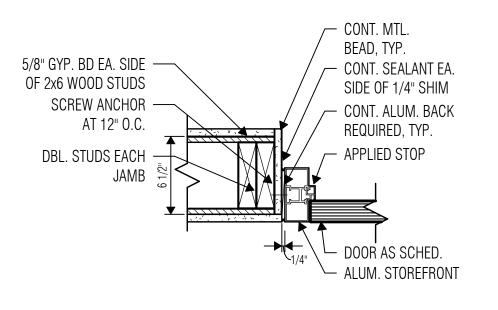SCALE: 3" = 1'-0"

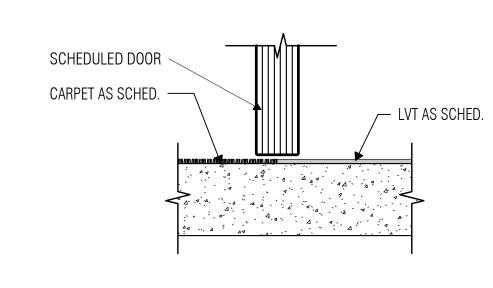

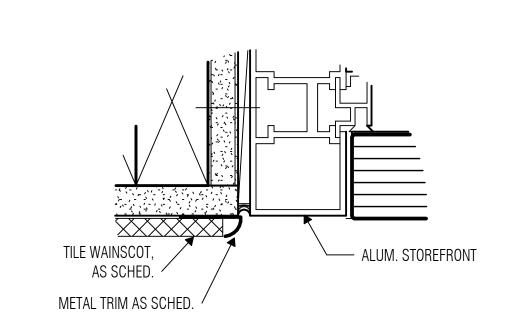

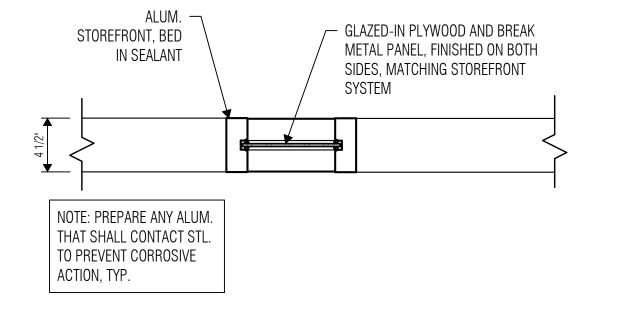

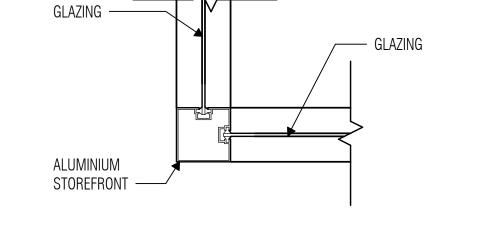


SILL DETAIL - LVT
SCALE: 3" = 1'-0"

1 TILE AT STOREFRONT
SCALE: 6" = 1'-0"

2 JAMB DETAIL - STOREFRONT
SCALE: 1 1/2" = 1'-0"



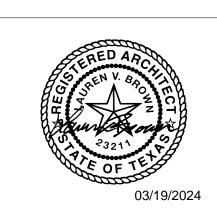

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REVISIO	NS
vision No.	Revision Date

03-19-2024 1 Addendum 01

> Director
> Approver
> Designer
> Designer
> Proj. Arch. Drawn By Author Checker

A7.12

Checker

MATERIAL & ROOM FINISH SCHEDULES

A9.01

IATERIALS, PRODUCTS, SIZES, CO	JI ORS AND PATTI		RIAL FINISH SC			
	PEOLIO VIAD I WILL	ERNS ARE THE BASIS OF D	DESIGN. REFERENCE PROJ	JECT MANUAL FOR ADDITIO	NAL APPROVED	MANUFACTURERS MEETING THE DESIGN I
SU	BSTITUTIONS WIL	L BE CONSIDERED WHEN	,	CE WITH SECTION 01 62 00	– PRODUCT OP	TIONS.
			T	I		_
DESCRIPTION	SPEC SECTION	MANUFACTURER	SERIES/STYLE	COLOR/FINISH	SIZE	COMMENTS
lwork -						
Electrical / Data Outlets	26 27 26	As Specified	As Specified	Gray Plugs in Stainless Steel Plate		
Fabric - Tackboard		'	'	, ,		GS Acoustics Acousti-Tack (ATF) Wall Panel
	26 27 26			·		
3	06 40 00 / 08 14 23	<u>'</u>	Premium Laminate			
Paint - H.M. Door Frame	09 91 00	Sherwin Williams		SW 7512 Pavilion Beige		
Paint - Storefront	08 41 13	PPG	Duranar	UC54137 Beige		
Roller Shades - Fabric	12 24 13	SWF Contract	Crosshatch R Series; R100 1%	C7913 Linen / Fog		
Roller Shades - System	12 24 13	SWF Contract	Precision + Cordless Manual	Clear Anodized 1		
Solid Surface	06 40 00	Formica		Tumbled Glass		
Toilet Compartment	10 21 13.19	Accurate Partitions Division	Solid Plastic HDPE	Metallic Bronze 9513 1		
Base - Metal	09 30 00	Schluter	DILEX-AHK	Cream	3/8"	
Base - Rubber	09 65 00	Roppe	Contours; Fashion PV6085	191 Camel	6"	
Base - Tile	09 30 00	Crossville	Gotham	Lamp Post	6" x 12"	
Acquetia Pofflog Mood Look	(00 51 12) ()	Acoutolt	Truce	Mino Parral	70 1/00 7/40 7/00	
						Crid. 15/16" White
3		Armstrong Centrings				Grid: 15/16" White Grid: 15/16" White
			·			Grid: 15/16" Wille
raint - Othing	09 91 00	SHEIWIII WIIIIdIIIS		SW 7000 LXIIA WIIILE		
Brick A	04 20 00	Acme	As Specified	As Specified		
Brick B	04 20 00	Acme	As Specified	As Specified		
Brick C	04 20 00	Acme	As Specified	As Specified		
	04 20 00	Acme	As Specified	As Specified		
·			•			
			•			
		· · · · · · · · · · · · · · · · · · ·	•			
Paint - Exterior hivi Doors and Frames	09 91 00	Sherwin williams	As Specified	Sw 7512 Pavillon Beige		
Concrete - Sealed	03 30 00	As Specified	As Specified	As Specified		
Carpet - Admin	09 68 13	Interface	Heart Strings	Paramour	50 cm x 50 cm	
Carpet - Walk-off	09 68 13	Milliken	OBEX Bar - Mono	Mono Grey	27.6 cm x 100 cm	Surface Mounted
Grout - Floor - A	09 30 00	Custom Building Products		#183 Chateau		Use for T-01
Grout - Floor - B	09 30 00	Custom Building Products		#370 Dove Gray		Use for T-02
LVT - Wood	09 65 00	Interface	Northern Grain	Natural Satin	25 cm x 1 m	Reference A9.11 for Install Pattern
-	09 30 00	Pantheon	Rally	Beige	24" x 24"	Add Traction Finish at Kitchen
Tile - Black	09 30 00	Pantheon	Rally	Anthracite	24" x 24"	Add Traction Finish
Corner Guard	10 26 13	Acrovyn	Vinyl - Pebble Texture	949 White	As Specified	Gypsum Board Outside Corners
Corner Guard - Kitchen	10 26 13	As Specified	As Specified	As Specified	As Specified	Kitchen Outside Corners
Transition - LVT to CO	09 65 00	Schluter	VINPRO-U	Brushed Nickel Anodized	5 mm (3/16")	LVT to Concrete
Transition - LVT to T	09 30 13	Schluter	RENO-TK	Brushed Nickel Anodized	10 mm (3/8")	LVT to Tile
Transition - Solid Surface	09 30 13	Grifform Innovations	TT2, with Bevels	Corian - Silverite		LVT to Tile at Toilets and Wet Areas
Trim - Metal - Tile Edge	09 30 00	Schluter	Jolly	Cream	10 mm (3/8")	
Trim - Metal - Tile Outside Corner	09 30 00	Schluter	Rondec	Cream	10 mm (3/8")	
FRP - Sanitary Wall Panel	09 72 21	Marlite	Pebbled Texture	P-100 White	As Specified	At Mop Sink; Reference 7/A3.21
Grout - Wall - A	09 30 00	Custom Building Products		#135 Mushroom		Use for T-03
Grout - Wall - B	09 30 00	Custom Building Products		#645 Steel Blue		Use for T-04
Paint - Field	09 91 00	Sherwin Williams		SW 7005 Pure White (255-C1)		
Paint - Accent	09 91 00	Sherwin Williams		SW 0055 Light French Gray		
Paint - Epoxy	09 91 00	Sherwin Williams	Ероху	SW 7006 Extra White (257-C1)		
Tile - White	09 30 00	Crossville	Gotham	Lamp Post	12" x 24"	
	09 30 00		WOW; Stripes	Sky	3" x 12"	
	Fabric - Tackboard Light Switches Plastic Laminate - Doors and Casework Paint - H.M. Door Frame Paint - Storefront Roller Shades - Fabric Roller Shades - System Solid Surface Toilet Compartment Base - Metal Base - Rubber Base - Tile Acoustic Baffles - Wood-Look Acoustic Ceiling Tile Acoustic Ceiling Tile - Vinyl Coated Paint - Ceiling Brick A Brick B Brick C Brick D Split Face Block Cast Stone GFRC Paint - Exterior HM Doors and Frames Concrete - Sealed Carpet - Admin Carpet - Walk-off Grout - Floor - A Grout - Floor - B LVT - Wood Tile - Beige Tile - Black Corner Guard Corner Guard - Kitchen Transition - LVT to CO Transition - LVT to CO Transition - LVT to CO Transition - LVT to T Transition - Solid Surface Trim - Metal - Tile Edge Trim - Metal - Tile Edge Trim - Metal - Tile Outside Corner FRP - Sanitary Wall Panel Grout - Wall - A Grout - Wall - A Grout - Wall - B Paint - Field Paint - Field Paint - Field Paint - Field	Nork - Electrical / Data Outlets 26 27 26 Fabric - Tackboard 99 84 13 Light Switches 26 27 26 Plastic Laminate - Doors and Casework 06 40 00 / 08 14 23 Paint - H.M. Door Frame 09 91 00 Paint - Storefront 08 41 13 Roller Shades - Fabric 12 24 13 Roller Shades - Fabric 12 24 13 Solid Surface 06 40 00 Toilet Compartment 10 21 13.19 Base - Metal 09 30 00 Base - Rubber 09 65 00 Base - Tile 09 30 00 Acoustic Baffles - Wood-Look 09 51 00 Acoustic Ceiling Tile 09 51 00 Paint - Ceiling 09 91 00 Brick A 04 20 00 Brick C 04 20 00 Brick C 04 20 00 Cast Stone 04 72 00 GFRC 03 49 00 Paint - Exterior HM Doors and Frames 09 91 00 Paint - Exterior HM Doors and Frames 09 30 00 Tile - Black 09 30 00 Transition - LVT to C 09 65 00 09 30 00 09 30 00 00 00 00	Nord	Description		DESCRIPTION SPEC SECTION MANUFACTURER SERES/STYLE COLOR/FINISH SIZE

00	COVERED PORCH	CO / CPT-02			
0101	LOBBY	T-01	RB-01	PT-01 / PT-02	
0102	CORRIDOR	LVT-01	TB-01	T-03 / T-04 / PT-01 / PT-02	PT-02 at ceiling above baffle
0103	HEAD OF SCHOOL	CPT-01	RB-01	PT-01	
0104	CONFERENCE	CPT-01	RB-01	PT-01 / PT-02	
0105	OFFICE	CPT-01	RB-01	PT-01	
0106	GEN STOR./CUST.	CO	RB-01	PTE-01	
0107	IT	LVT-01	RB-01	PT-01	
0108	MECH/ELEC	CO	RB-01	PTE-01	
0109	CLASSROOM	LVT-01	RB-01	PT-01	
0109C	COT. STOR.	LVT-01	RB-01	PT-01	
0109D	CHILD RR	T-02	MB-01	T-03	
0109E	CHILD RR	T-02	MB-01	T-03	
0109F	CR STG.	LVT-01	RB-01	PT-01	
0110	PLAY AREA STORAGE	CO	RB-01	PT-01	
0111	CLASSROOM	LVT-01	RB-01	PT-01	
0111C	COT STOR.	LVT-01	RB-01	PT-01	
0111D	CR STG.	LVT-01	RB-01	PT-01	
0112	ADULT RR	T-02	MB-01	T-03 / T-04	
0113	CHILD RR	T-02	MB-01	T-03 / T-04	
0114	PLAY AREA STORAGE	CO	RB-01	PT-01	
0115	CLASSROOM	LVT-01	RB-01	PT-01	
0115D	CR STG.	LVT-01	RB-01	PT-01	
0116	CLASSROOM	LVT-01	RB-01	PT-01	
0116D	CR STG.	LVT-01	RB-01	PT-01	
0117	ADULT RR	T-02	MB-01	T-03 / T-04	
0118	CHILD RR	T-02	MB-01	T-03 / T-04	
0119	PLAY AREA STORAGE	CO	RB-01	PT-01	
0120	CLASSROOM	LVT-01	RB-01	T-03 / T-04	
0120C	COT STOR.	LVT-01	RB-01	PT-01	
0120D	CR STG.	LVT-01	RB-01	PT-01	
0121	CLASSROOM	LVT-01	RB-01	PT-01	
0121C	COT STOR.	LVT-01	RB-01	PT-01	
0121D	CHILD RR	T-02	MB-01	T-03 / T-04	
0121E	CHILD RR	T-02	MB-01	T-03 / T-04	
0121F	CR STG.	LVT-01	RB-01	PT-01	
0122	PLAY AREA STORAGE	CO	RB-01	PT-01	
0123	LAUNDRY	T-01	RB-01	PTE-01	
0124	KITCHEN	T-01	MB-01	T-05	
0125	TEACHER'S LOUNGE	T-01	RB-01	PT-01 / PT-02	

ROOM FINISH SCHEDULE

COMMENTS

ROOM NUMBER ROOM NAME FLOOR BASE

V L K | A R C H I T E C T S ARCHITECT

Fort Worth, Texas 76104

Main Phone: 817.633.1600

www.vlkarchitects.com

b. Countertops shall be SLD-01. c. Interior Plastic Laminate clad wood doors to be PL-01. d. Window Sills shall be SLD-01. 2. **Ceiling Finishes**

shall be PL-01, unless noted otherwise.

brought to the architect's attention for resolution.

A. Refer to Reflected Ceiling Plans for scheduled finish.

General Finish Notes

B. Plastic Laminate

scheduled color, including mechanical ductwork, electrical, piping, conduit, j-boxes, etc. C. All interior gyp. bd. ceilings to be painted PT-04, unless noted otherwise.

B. At ceilings with exposed structure, all exposed elements shall be painted the

FINISH SCHEDULE NOTES

A. Any finish conflict between finish schedules and finish floor plans to be

a. Typical Casework/Millwork cabinet body, doors, and drawer fronts

D. All interior gyp. bd. furr-downs to be painted PT-01, unless noted otherwise. Floor Finishes A. Refer to Interior Finish Plans for floor finish patterns.

indicated, center in middle of the room or corridor. C. All changes in floor material between rooms shall occur at centerline of doorway, unless noted otherwise. D. Level and float flooring at public corridor walls. E. All toilets and other areas capable of water mitigation shall have a 2" $\times 1/2$ " marble threshold with double 1/4" bevel edge. The thresholds shall be held in

B. Refer to Interior Finish Plans for tile origin in each room. If origin point is not

place with thin set. F. Sealant color shall match adjacent material. G. Typical flooring application at brick walls:

a. LVT: Rake brick joint at floor level and install sealant between LVT and

b. Carpet: Rake brick joint at floor level and tuck carpet tight into raked brick joint.

4. Wall Finishes A. Finishes shall continue to inside corner, unless noted otherwise. B. At painted CMU base, color shall match the wall above.

C. Provide CG-01 at all outside gyp. bd. corners, whether indication on finish plans or not. CG-01 should go to ceiling. D. Paint Information:

a. Interior Paint

 All exterior walls with gyp. bd. interior are to be painted PT-01, unless noted otherwise. All interior sealants shall be painted to match adjacent wall.

b. Hollow Metal Doors and Windows: Hollow metal doors to be painted PT-05, unless noted otherwise Hollow metal door frames and vision panel frames shall be painted PT-03, unless noted otherwise.

 At door frames with 2 different colors, transition color at inside corner of door stop, on the door side of the stop. Hollow metal glazed opening frames shall be painted PT-03,

A. Refer to Detail 14/A3.21 for typical porcelain tile wall pattern. B. Refer to Sheet A2.31 for typical toilet room wall patterns.

unless noted otherwise.

C. At outside corners and exposed edges of ceramic or porcelain tile, provide anodized aluminum trim, unless otherwise detailed. D. Provide TR-01 and TR-02 at all outside and/or exposed tile locations (top,

bottom, and corners) in corridors, whether indicated on finish plans or not.

ISSUED: FEB 29, 2024 **REVISIONS**

Revision No. Revision Date 1 Addendum 01

Drawn By Director Approver Author Designer Designer Proj. Arch.

23-018.00

SHEET TITLE

SHEET NO.

Drawn By Director Approver Author Designer **Quality Control** Designer Proj. Arch.

Checker PROJECT NO.

23-018.00 SHEET TITLE

INTERIOR FINISH & FURNITURE PLAN

SHEET NO.

A9.11

APPLIANCE	BRAND	MODEL TYPE 1	MODEL DESCRIPTION 1	√ # UNITS	BY LEASEE	BY OWN
REFRIGERATOR	TURBO AIR	M3R-47-2-N	REFRIGERATOR, DOUBLE DOOR, REACH-IN, 47 CF	2	Х	
FREEZER	TURBO AIR	M3F-28-1-N	23 CF, SINGLE DOOR, FREEZER	1	X	
WARMER	FWE	RH-18	RETHERMALIZER	1	X	
DISHWASHER	CHAMPION	UH330-B	DISHWASHER, HIGH TEMPERATURE	1	Х	
THREE COMP. SINK	ADVANCE TABCO	BUILT TO SPEC		1		Х
SS WIRE SHELVES W/ MICROBAN COATING	METRO	CUSTOM		1	Х	
SINK FAUCET AND PRE-RINSE SPRAYER	TS BRASS	PRE-RINSE FAUCET ASSEMBLY W/ ADD-ON FAUCET		1		X
WASHER	WHIRLP00L	WFW6605MW	5.0 FT ³ , STACKABLE	2	X	
DRYER	WHIRLPOOL	WED5605MW	7.0 FT ³ , STACKABLE	2	X	
HAND WASH SINK	REF. PLUMBING	REF. PLUMBING	REF. PLUMBING	1		Х
MICROWAVE	REF. PLUMBING	REF. PLUMBING	REF. PLUMBING	2		Х
RESIDENTIAL REFRIGERATOR	REF. PLUMBING	REF. PLUMBING	REF. PLUMBING	1	Х	

INTERIOR FINISH LEGEND

CONCRETE, SEALED

CARPET - FIELD [50cm x 50cm]

CARPET - WALK-OFF [27.6 cm x 100 cm]


LUXURY VINYL TILE - FIELD [25cm x 1m]

LUXURY VINYL TILE - HERRINGBONE

PORCELAIN TILE - FIELD [24" x 24"]

PORCELAIN TILE - ACCENT [24" x 24"]

INSTALL [25cm x 1m]

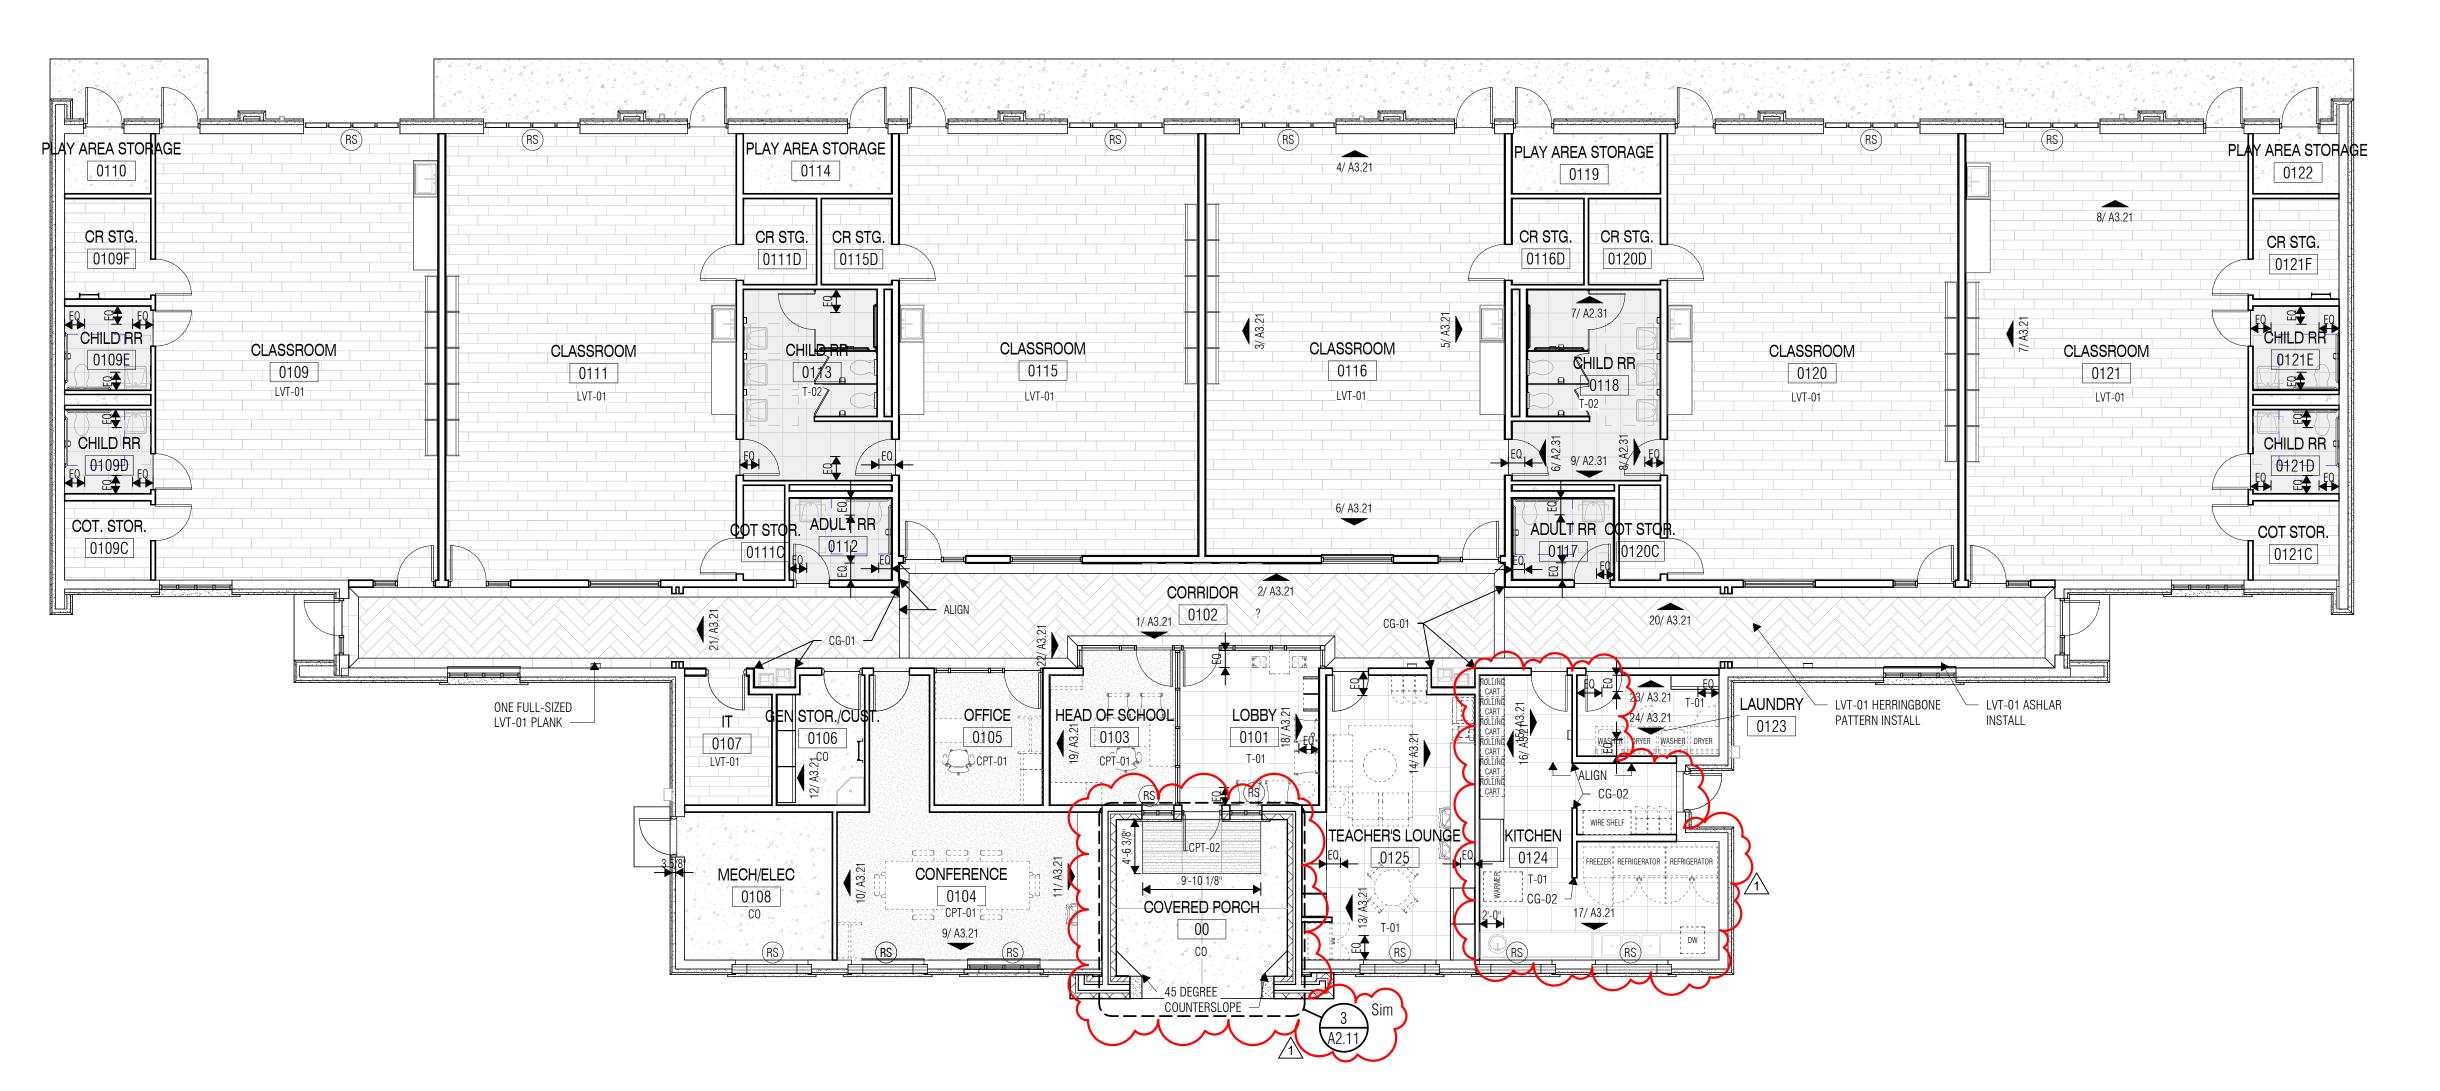

) INTERIOR FINISH PLAN - LEVEL ONE SCALE: 1/8" = 1'-0"